ELMONICA STATION



LAND USE 08.03.23







REVISIONS:

SHEET:

08/03/23

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ELMONICA STATION

REFRIGERATOR

RANGE HOOD

RESTROOM

STORAGE

TYPICAL

VERIFY

WITH

WASHER

WATER CLOSET

WOOD I-JOISTS

CUBIC YARD

SIM

STL

STR

T & G

TO

TYP

UNO

VFY

SQUARE FOOT

STAINLESS STEEL

TONGUE AND GROOVE

ROUGH OPENING

SELF-ADHERED MEMBRANE FLASHING

SOUND TRANSMISSION CLASS

UNDERWRITERS LABORATORIES

UNLESS NOTED OTHERWISE

WEATHER-RESISTIVE BARRIER

ABBREVIATIONS

@	AT	GFRC	GLASS FIBER REINFORCED CONCRETE
AC	AIR CONDITIONING / ACRES	GYP	GYPSUM BOARD
ADJ	ADJUSTABLE	HR	HOUR
AFF	ABOVE FINISHED FLOOR	INFO	INFORMATION
ALUM	ALUMINUM	INSUL	iNSULATION
ASSY	ASSEMBLY	INT	INTERIOR
ASTM	AMERICAN SOCIETY FOR TESTING AND MATERIALS	JAN	JANITOR'S CLOSET
BD	BOARD	MAX	MAXIMUM
BM	BEAM	MDF	MEDIUM-DENSITY FIBERBOARD
CL	CENTERLINE	MECH	MECHANICAL
CLR	CLEAR	MFR	MANUFACTURER
COL	COLUMN	MIN	MINIMUM
COMM	COMMUNICATION(S)	MIRR	MIRROR
CONC	CONCRETE	MTL	METAL
CONT	CONTINUOUS	N/A	NOT APPLICABLE
D	DRYER	NO	NUMBER
DBL	DOUBLE	NR	NON RATED
DIA	DIAMETER	NTS	NOT TO SCALE
DIM	DIMENSION	OC	ON CENTER
DN	DOWN	OCC	OCCUPANT(S), OCCUPANCY(IES)
DS	DOWNSPOUT	OD	OVERFLOW DRAIN
DW	DISHWASHER	OFC	OREGON FIRE CODE
EA	EACH	OLF	OCCUPANT LOAD FACTOR
ELEC	ELECTRICAL	OPP	OPPOSITE
ELEV	ELEVATOR	OSSC	OREGON STRUCTURAL SPECIALTY CODE
EQ	EQUAL	PERF	PERFORATED / PERFORATION
EXT	EXTERIOR	PL	PROPERTY LINE, PLATE
FCP	FIBER CEMENT PLANEL	PLAM	PLASTIC LAMINATE
FD	FLOOR DRAIN	PLWD	PLYWOOD
FEC	FIRE EXTINGUISHER CABINET (FIRE	PNT	PAINT
	EXTINGUISHER)	PT	PRESERVATIVE TREATED, POST-TENSION
FND	FOUNDATION	PTHP	PACKAGE TERMINAL HEAT PUMP
EO6	EVCE OE STIID	OTV	OLIANITITY

QUANTITY

REFER, REFERENCE

GENERAL NOTES

- ALL DIMENSIONS ARE TO FACE OF STUD UNO OR CENTER OF WINDOW OPENING, COLUMN, EXTERIOR DIMENSIONS ARE TO FACE OF FOUNDATION/FACE OF FRAMING. DIMENSIONS INDICATED AS "CLR" ARE TO FACE OF
- DASHED BOXES AND CIRCLES ON PLAN DESIGNATE REQUIRED ACCESSIBLE OR EQUIPMENT CLEAR FLOOR

PROJECT DESCRIPTION

ELMONICA IS AN AFFORDABLE HOUSING DEVELOPMENT IN BEAVERTON, OREGON, LOCATED AT THE INTERSECTION OF W BASELINE RD AND 170TH AVE. THE PROJECT IS FOUR STORIES TALL AND WILL HAVE 81 APARTMENTS, RANGING FROM STUDIOS, 1-BEDROOM, 2-BEDROOM, AND 3-BEDROOM UNITS.

SHEET INDEX

GENERAL	
G0.00	COFFEE COVER
G0.01	COVER SHEET
G0.02	SITE REFERENCE PLAN
G0.03	ACCESS & CIRCULATION

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0.50	EXISTING CONDITIONS	
1.00	TYPICAL SECTIONS	
2.00	GRADING PLAN	
3.00	UTILITY PLAN	

LANDSCAPE TREE REMOVAL PLAN MATERIALS PLAN PLANTING PLAN PLANTING SCHEDULE & NOTES ENLARGED PLANTING PLANS ENLARGED PLANTING PLANS L5.03

ARCHITE	CTURAL		
A1.01	LEVEL 01 PLAN		
A1.02	LEVELS 02-04 PLAN		
A1.03	ROOF PLAN		
A2.01	BUILDING ELEVATIONS		

PROJECT TEAM

CLIENT

REACH CDC

ARCHITECT

4150 S MOODY AVE

PORTLAND, OR 97239

PHONE: 323.547.9634

CONTACT: ALEX ALEMAN

SALAZAR ARCHITECT, INC

CONTACT: DARIIA VERNYGORA

PORTLAND, OR 97232

PHONE: 503.702.2575

GENERAL CONTRACTOR

PORTLAND, OR 97209

PHONE: 503 358 0722

CIVIL ENGINEER

COLAS CONSTRUCTION, INC.

CONACT: MARC-DANIEL DOMOND

110 SE MAIN STREET, SUITE 200

CONTACT: KRISTIAN MCCOMBS

CONTACT: MIGUEL CAMACHO-SERNA

19 NW 5TH AVE, SUITE 203

HUMBER DESIGN GROUP

PORTLAND, OR 97214

PHONE: 503.946.6690

LANDSCAPE ARCHITECT

735 NW 18TH AVENUE PORTLAND, OR 97209

PHONE: 503 334 2080

ARRIS CONSULTING 5247 NE 49TH AVE PORTLAND, OR 97218

PHONE: 503.757.2611

ELECTRICAL

CONTACT: BRIAN BUTLER

INTERFACE ENGINEERING

PORTLAND, OR 97204 PHONE: 503.382.2266 CONTACT: MARK JACKSON

STRUCTURAL ENGINEER

CLACKAMAS, OR 97015 PHONE: 503.758.8092 CONTACT: BASSAM BAZZI

LAND USE PLANNER

PORTLAND, OR 97204 PHONE: 503.757.1211

ACOUSTIC ENGINEER

PHONE: 206.899.5450 CONTACT: ERIK MILLER-KLEIN

BUILDING ENVELOPE

TROUTDALE, OR 97060 PHONE: 503 328 9549

ADDRESS

100 SW MAIN STREET, SUITE 1600

VALAR CONSULTING ENGINEERING

12042 SE SUNNYSIDE ROAD #357

506 SW 6TH AVENUE, 4TH FLOOR

CONTACT: CARRIE BRENNECKE

TENOR ENGINEERING GROUP

1049 NW CORPORATE DRIVE,

CONTACT: DEVIN FOLLINGSTAD

QUALIFIED ENCLOSURE CONSULTANTS (QEC)

MECHANICAL & PLUMBING

2222 NE OREGON STREET, SUITE 101


A2.02	BUILDING ELEVATIONS
A2.03	BUILDING ELEVATIONS - ARTICULATION
A2.04	BUILDING ELEVATIONS - ARTICULATION
A2.05	VISUALIZATION

A2.06

PHOTOMETRIC PLAN - ROW SITE PLAN - PHOTOMETRICS

VISUALIZATION

SYMBOLS

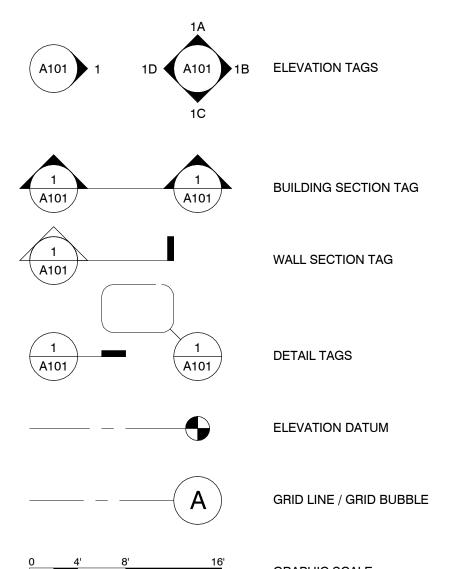


FORMABLE SELF-ADHERED MEMBRANE FLASHING

GAUGE OR GYPSUM ASSOCIATION

GALVANIZED OR GALVANIC



ROOM NAME ROOM TAG 101

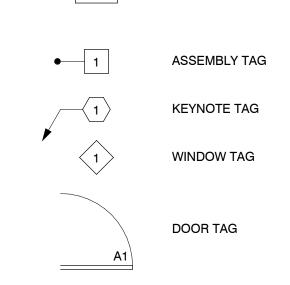



VICINITY MAP



□ RECTANGULAR COLUMNS - CONCRETE

O ROUND COLUMNS - CONCRETE

PARKING UNDER BUILDING □ INTERIOR BUILDING SPACE

SECONDARY BUILDING ENTRANCE PRIMARY BUILDING ENTRANCE

UNIT MIX

UNIT TYPE	GROSS AREA (SF)	# OF UNITS	% OF UNITS
STUDIO	445	24	30%
1-BD	596	24	30%
2-BD	877	18	22%
3-BD	1,035	15	18%
TOTALS		<u>81</u>	100%

PARKING COUNT

BICYCLE PARKING REQUIRED	# OF SPACES
SHORT TERM = 1 PER 20 UNITS	5
LONG TERM = 1 PER UNIT	81
TOTALS	<u>86</u>

BICYCLE PARKING PROVIDED	# OF SPACES
SHORT TERM	6
LONG TERM	82
TOTALS	<u>88</u>

MOTOR VEHICLE PARKING REQUIRED	# OF SPACES
1 PER UNIT	81

PARKING PROVIDED	TYP.	<u>ADA</u>
PARKING UNDER BLDG	31	1
FESTIVAL STREET	12	2
SUB TOTALS	43	3
TOTAL (0.57)	<u>46</u>	
		,

2222 NE OREGON ST. SUITE 101 PORTLAND, OR 97232 PHONE: 503.702.2575 WWW.SALAZARCH.COM

PROJECT NUMBER: **ELMONICA**

17030 SW BASELINE ROAD BEAVERTON, OR 97006

STATION

CLIENT:

REACH CDC

4150 S MOODY AVE PORTLAND, OR 97239

LAND USE

AREA CALCULATIONS

SITE AREA	SF	<u>%</u>
L1 BUILDING FOOTPRINT	8,511 SF	20 %
PARKING & DRIVING	19,433 SF	46 %
LANDSCAPING / OPEN SPACE	14,201 SF	34 %
TOTAL SITE AREA	42,145 SF	<u>100 %</u>

BUILDING AREA	<u>SF</u>	<u>%</u>
LEVEL 1	7,842 SF	10 %
LEVEL 2	23,144 SF	29.9 %
LEVEL 3	23,144 SF	29.9 %
LEVEL 4	23,144 SF	29.9 %
LEVEL ROOF	190 SF	0.3 %
TOTAL	77,464 SF	<u>100 %</u>
FAR (PER BDC DEF.)	1.84	

REVISIONS:


DATE DESCRIPTION

SHEET TITLE: SITE REFERENCE **PLAN**

DRAWN BY: CHECKED BY: DATE CREATED:

SHEET:


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W BASELINE ROAD

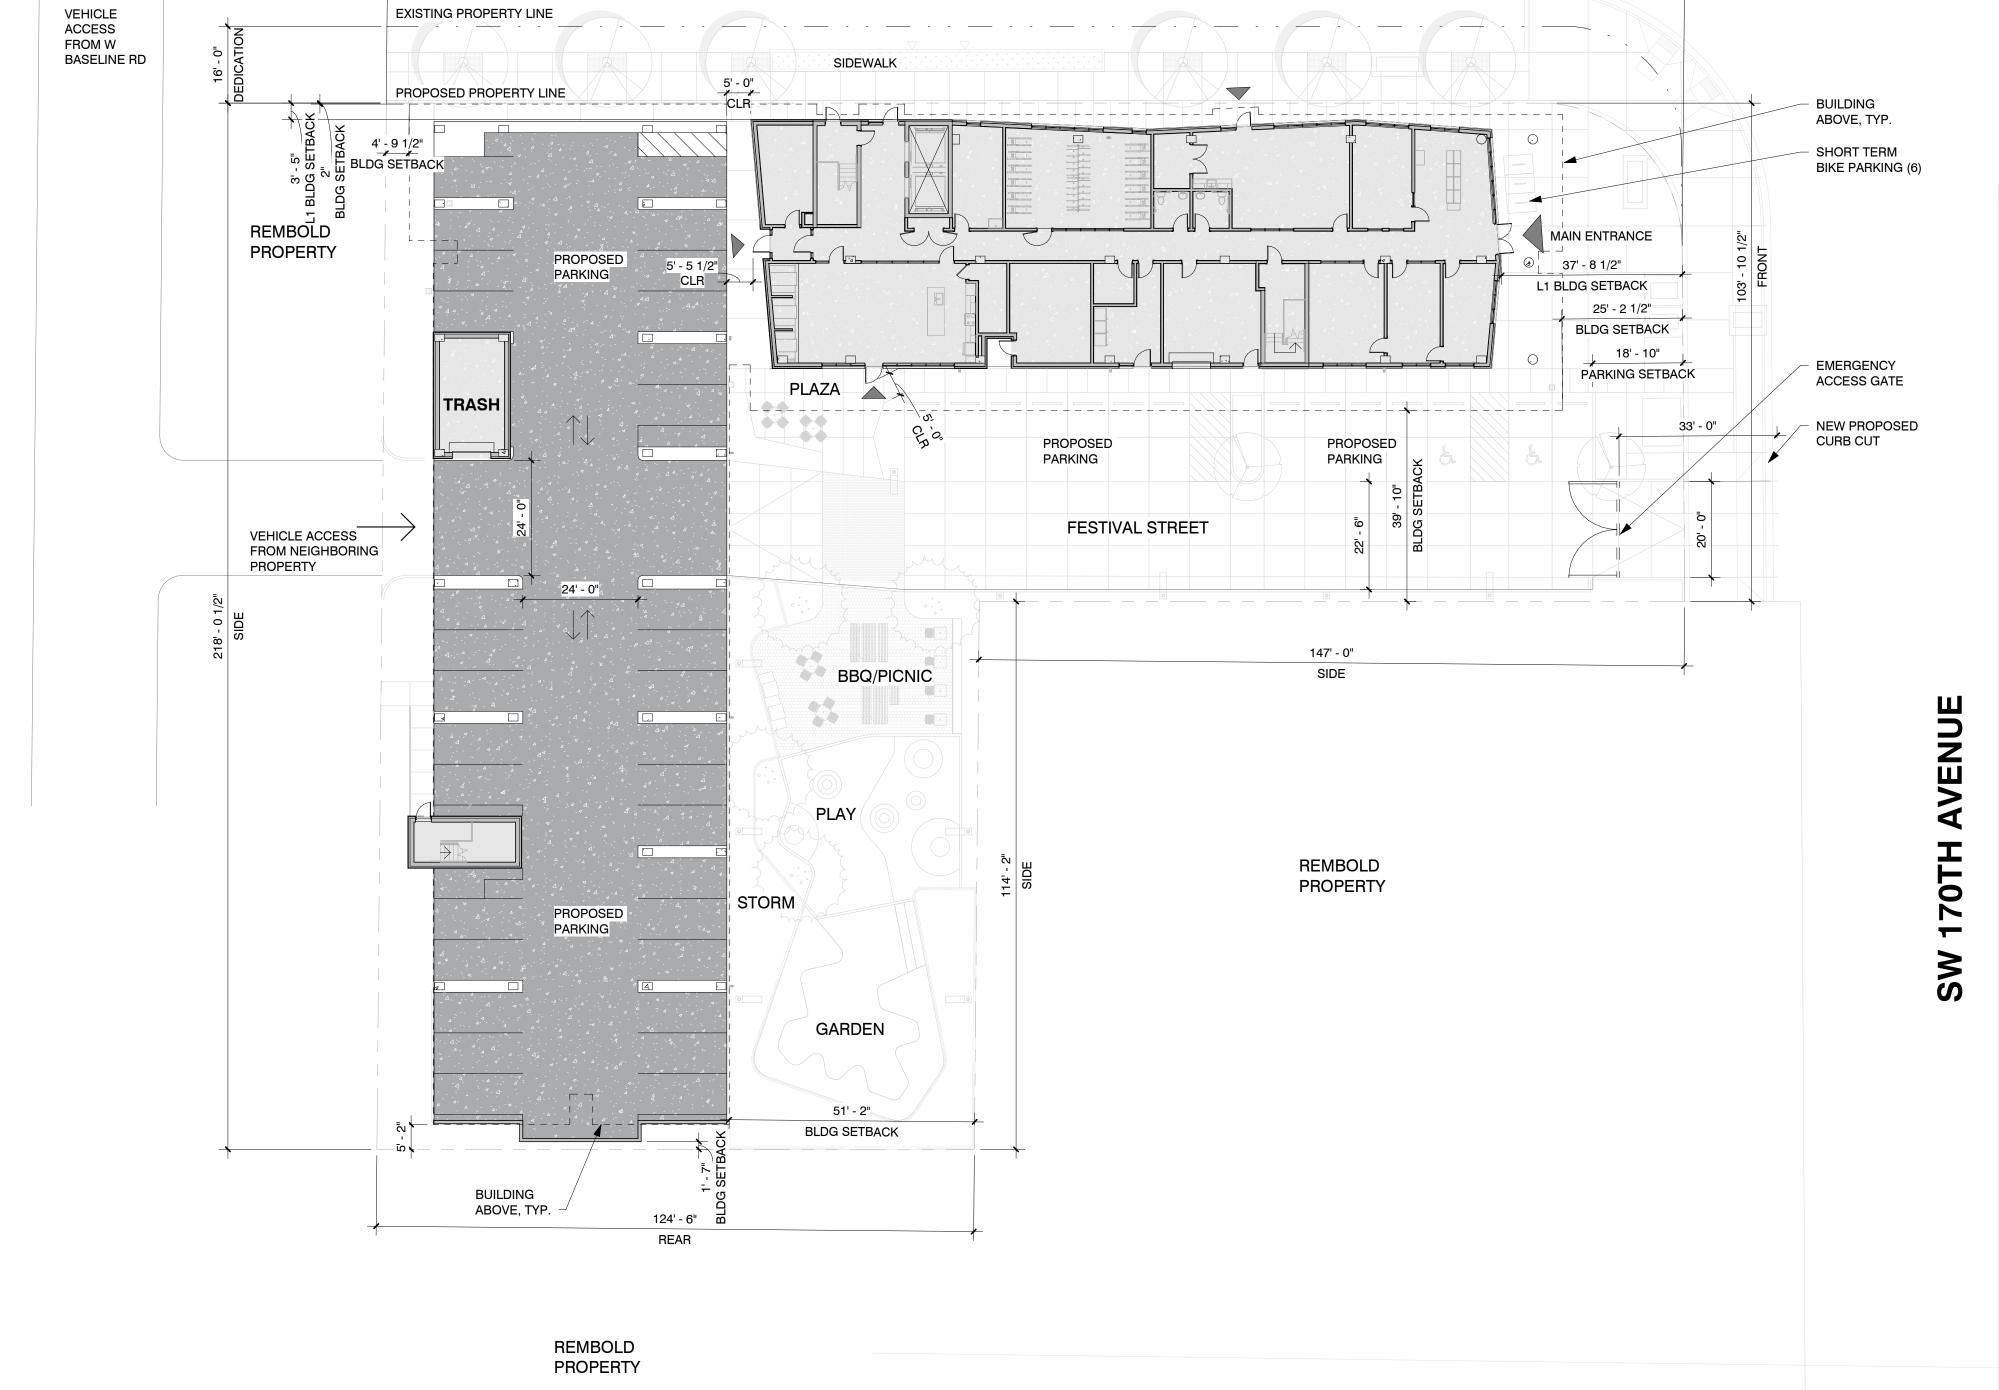270' - 4"





G0.03

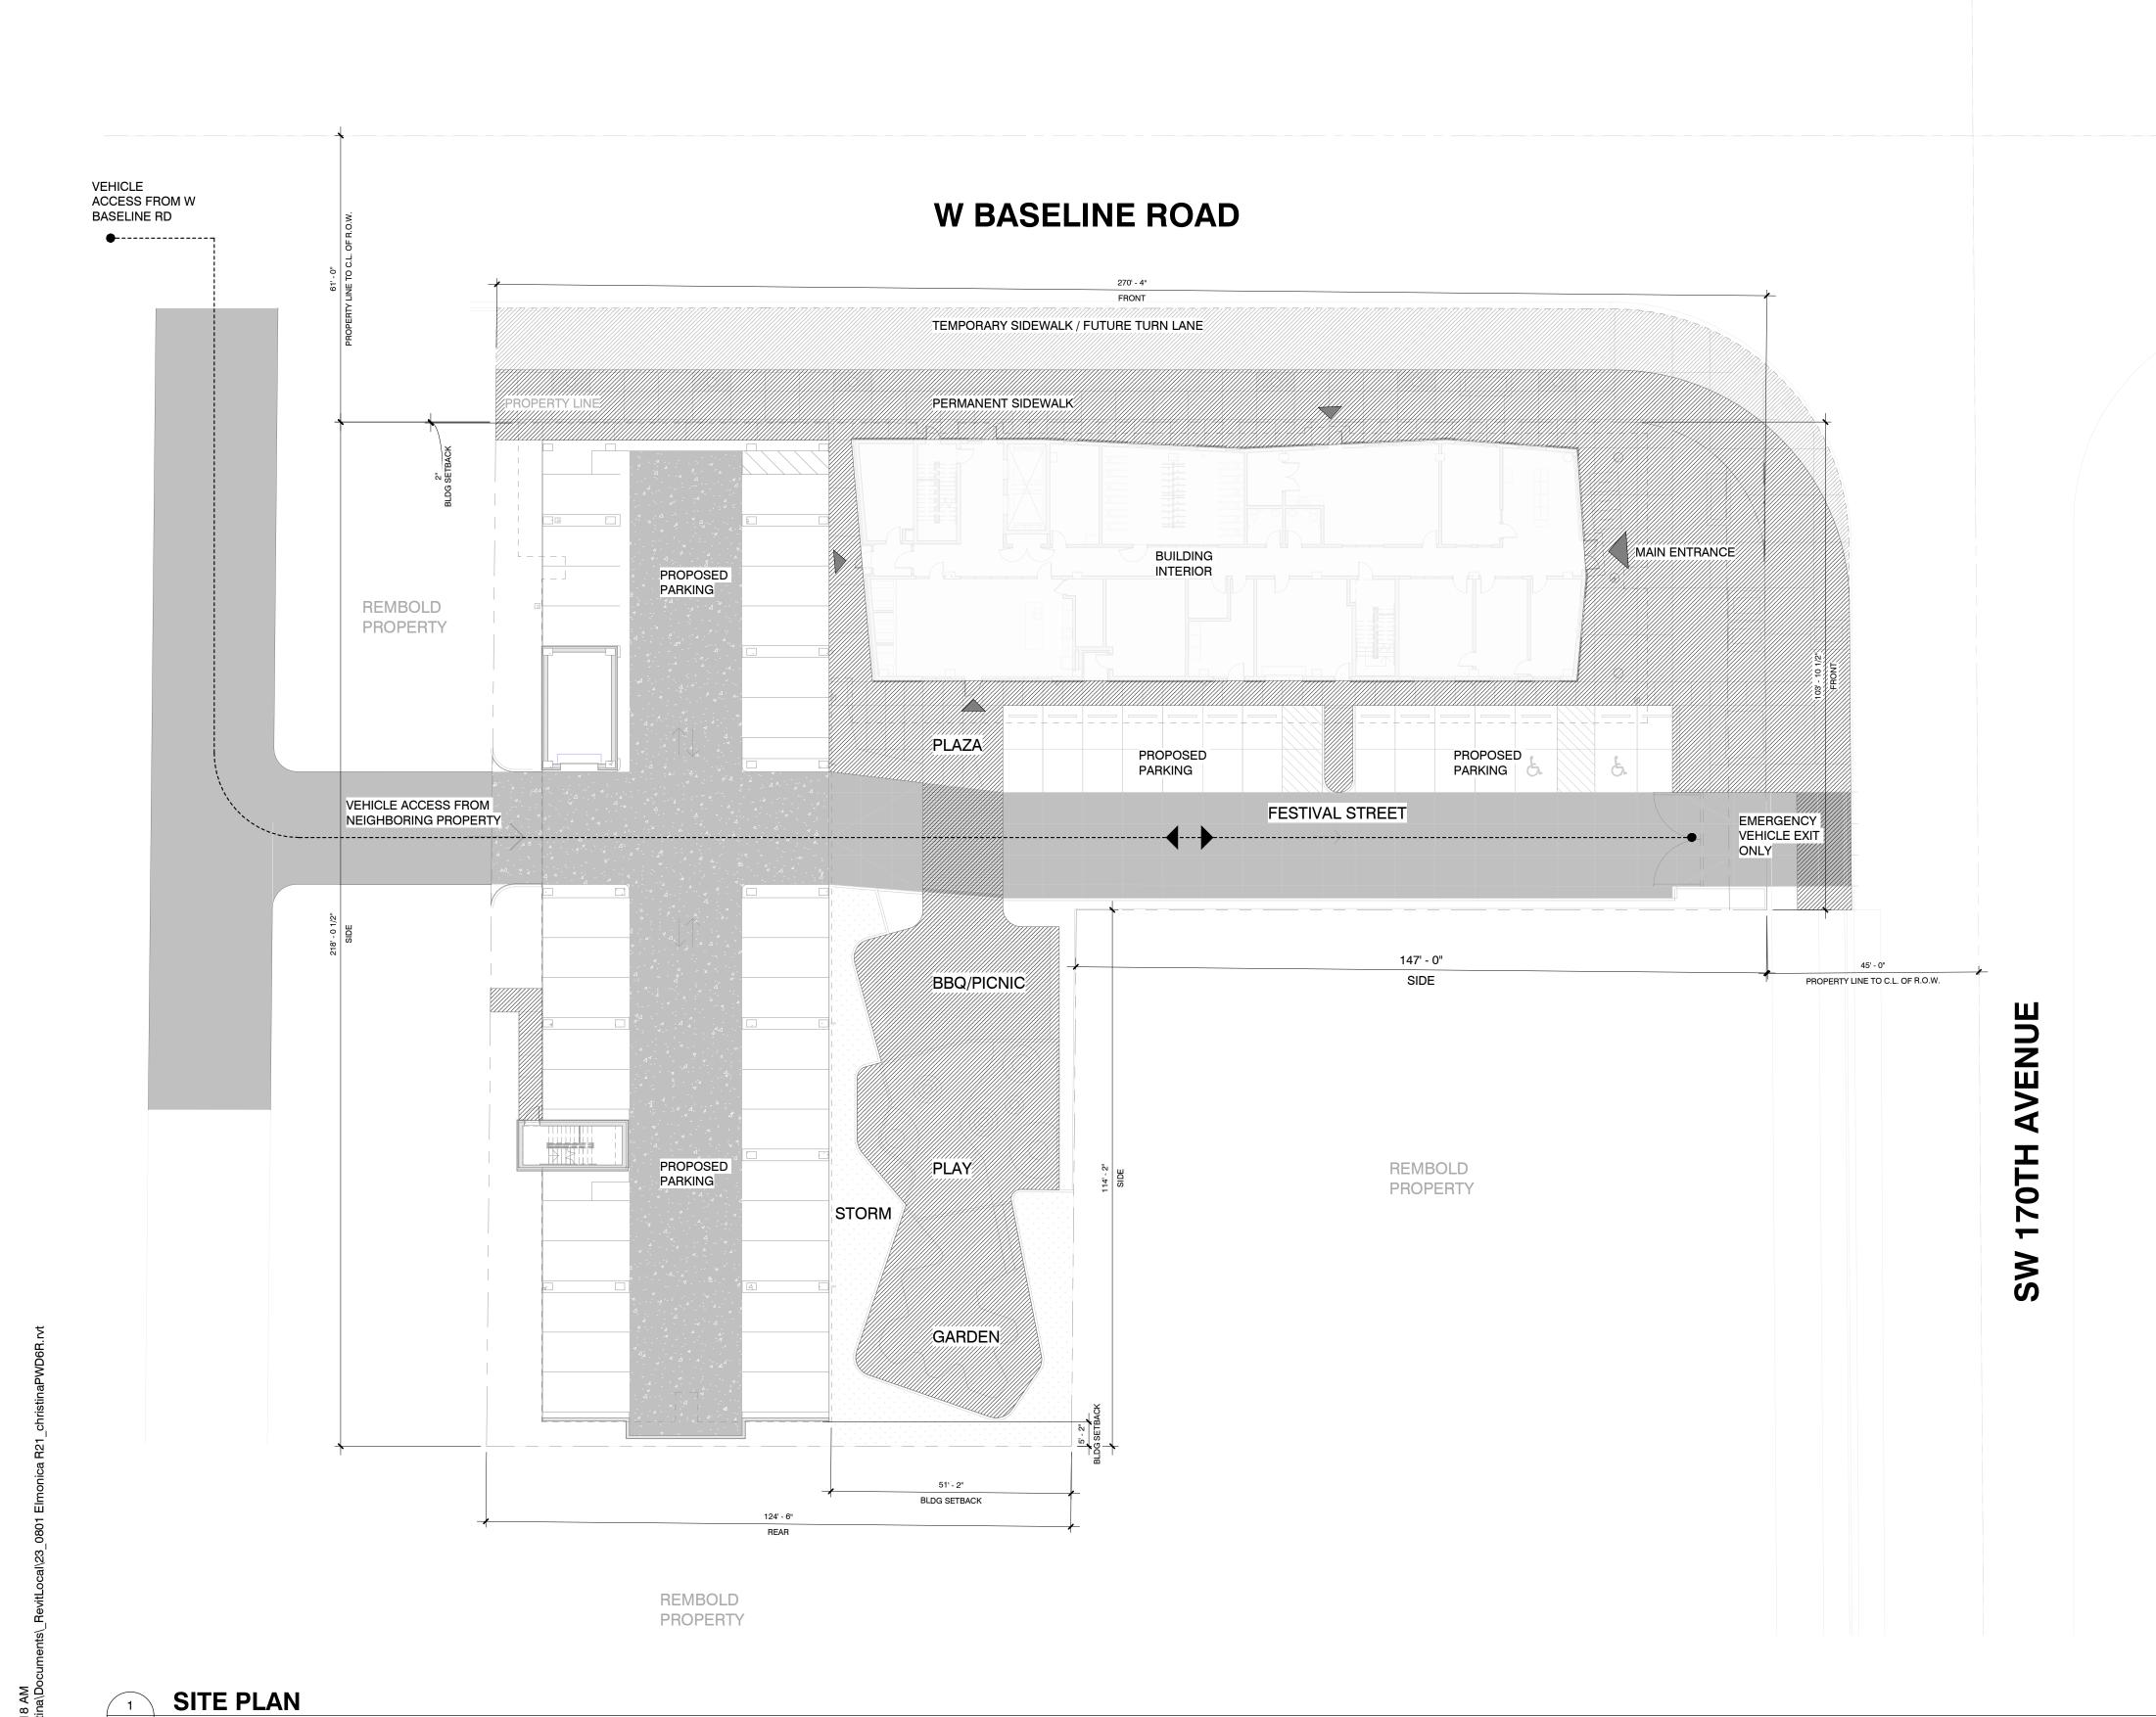PLAN LEGEND

□ RECTANGULAR COLUMNS - CONCRETE

O ROUND COLUMNS - CONCRETE

□ INTERIOR BUILDING SPACE

SECONDARY BUILDING ENTRANCE

PRIMARY BUILDING ENTRANCE

VEHICLE PATH

PEDESTRIAN PATH (TEMPORARY SIDEWALK)

PEDESTRIAN PATH (PERMANENT SIDEWALK)

PEDESTRIAN PATH CROSSING VEHICLE PATH



PROJECT NUMBER:

ELMONICA STATION

17030 SW BASELINE ROAD BEAVERTON, OR 97006

CLIENT:

REACH CDC

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LAND USE

REVISIONS:

DATE DESCRIPTION

SHEET TITLE: **ACCESS & CIRCULATION**

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ELMONICA

STATION

CLIENT:

REACH CDC

4150 S MOODY AVE PORTLAND, OR 97239 Humber Design

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EXPIRES 12-31-2024

LAND USE

REVISIONS:

_______ DATE DESCRIPTION SHEET TITLE:


EXISTING CONDITIONS **PLAN**

DRAWN BY: CHECKED BY: DATE CREATED:

AX/MCS

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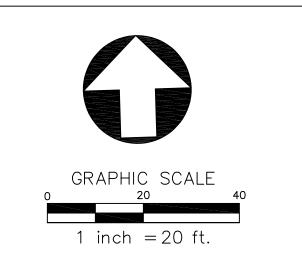
- 1. TOTAL EXISTING SITE AREA = 46,541 SF
- 2. SITE IS NOT LOCATED WITHIN THE 100-YEAR FLOODPLAIN.
- 3. PER CITY OF BEAVERTON'S INVENTORIES, THE SITE DOES NOT INCLUDE NATURAL RESOURCE AREAS, SIGNIFICANT TREES, AND HISTORIC TREES
- PER CLEAN WATER SERVICES STANDARDS, THE SITE IS NOT WITHIN SENSITIVE AREAS.
- 5. NO WETLAND BOUNDARIES, UPLAND WOODED AREA BOUNDARIES, RIPARIAN BOUNDARIES, ROCK OUTCROPPINGS, AND STREAMS FALL WITHIN THE SITE AREA.


DESCRIPTION

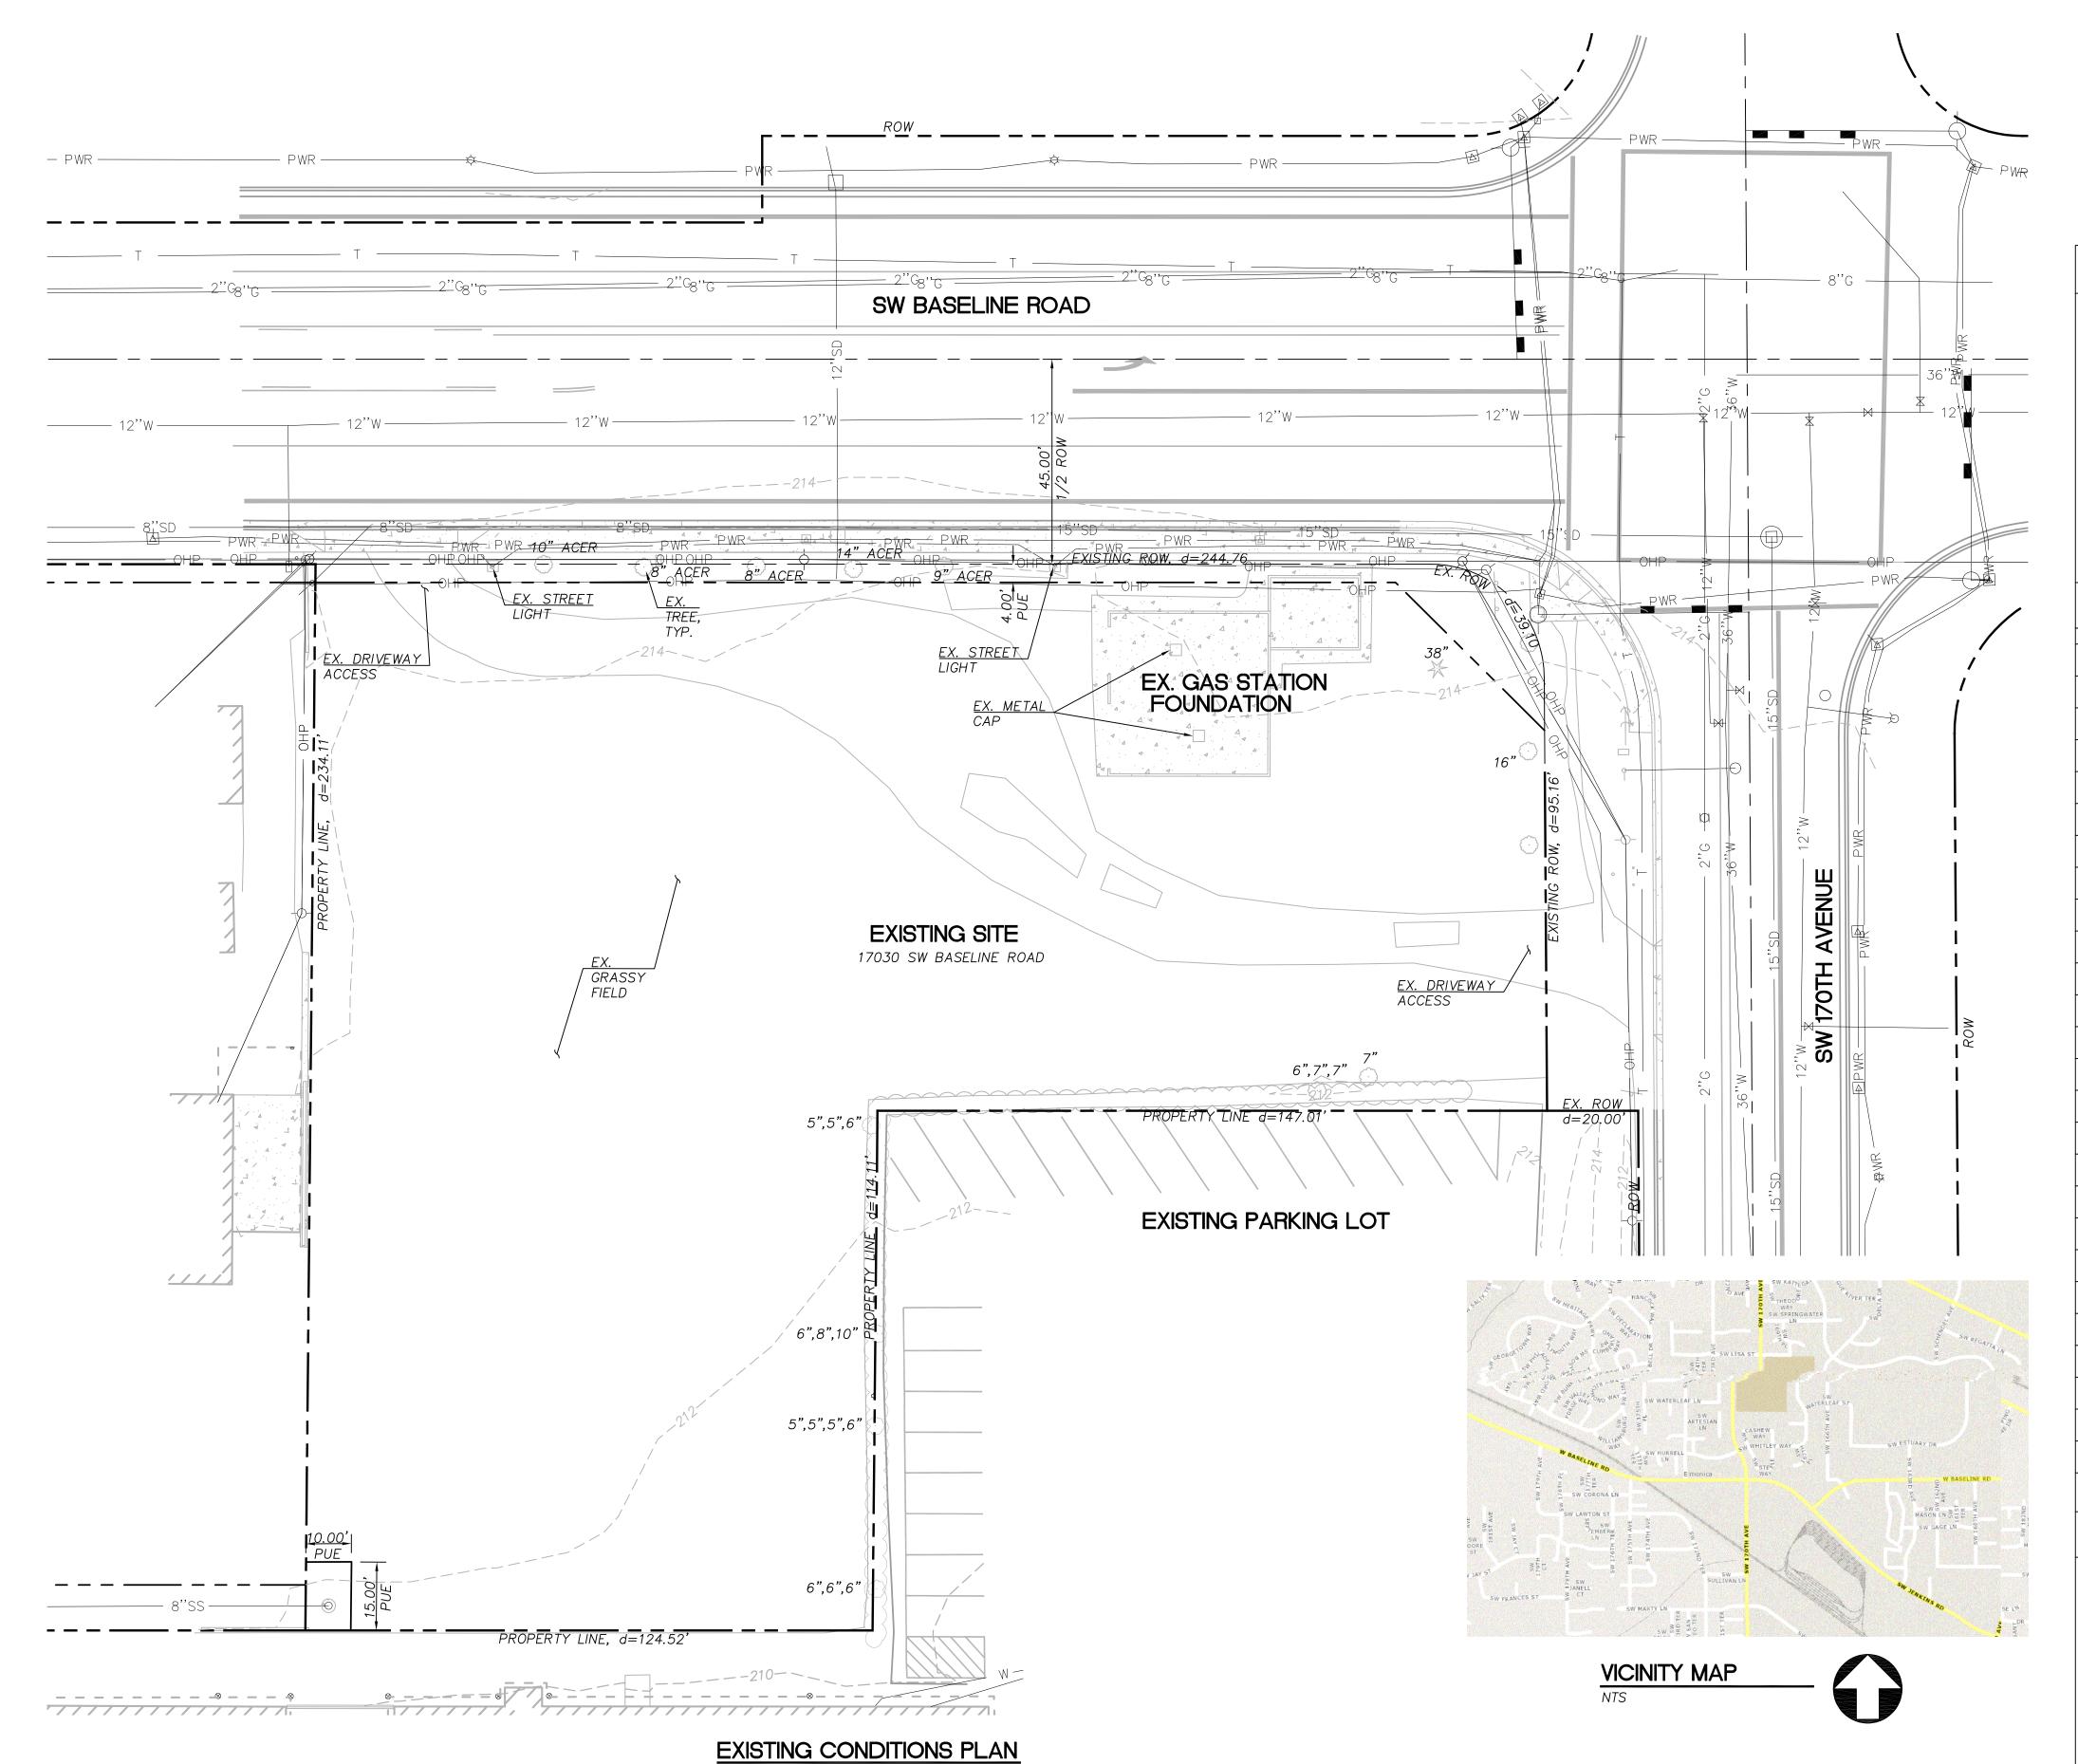LEGEND
SYMBOL
~~

0	DECIDUOUS TREE
X	CONIFEROUS TREE
Q	FIRE HYDRANT
Ŷ	WATER BLOWOFF
	WATER METER
M	WATER VALVE
⊠	DOUBLE CHECK VALVE
Ŕ	AIR RELEASE VALVE
0	SANITARY SEWER CLEAN OUT
0	SANITARY SEWER MANHOLE
	SIGN
\$	STREET LIGHT
[MB]	MAILBOX
0	STORM DRAIN CLEAN OUT
	STORM DRAIN CATCH BASIN
	STORM DRAIN AREA DRAIN
	STORM DRAIN MANHOLE
O	GAS METER
(D)	GAS VALVE
←	GUY WIRE ANCHOR
-0-	UTILITY POLE
Р	POWER VAULT
Δ	POWER JUNCTION BOX
	POWER PEDESTAL
C	COMMUNICATIONS VAULT
Δ	COMMUNICATIONS JUNCTION BOX
٥	COMMUNICATIONS RISER

NORTH ARROW + SCALE BAR



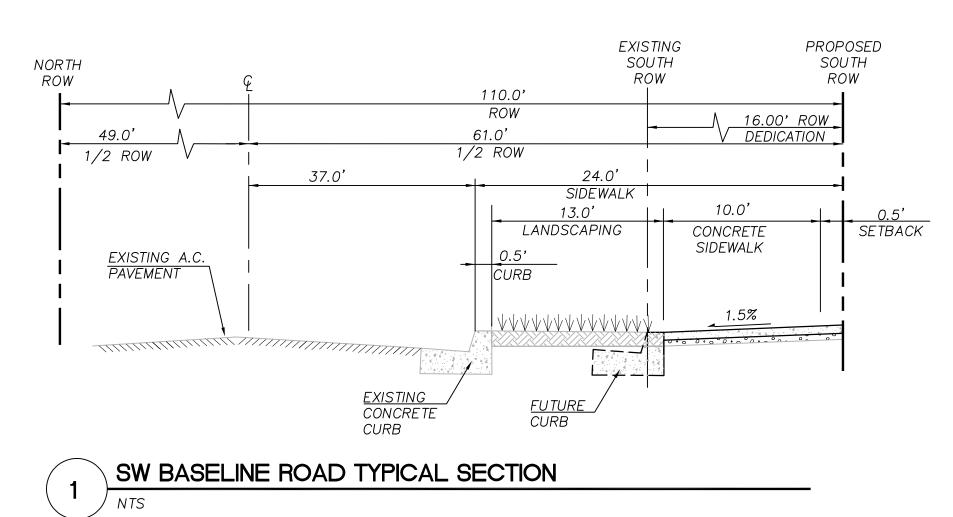

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PROJECT NUMBER:

ELMONICA STATION

17030 SW BASELINE ROAD BEAVERTON, OR 97006

CLIENT:

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SITE **DEVELOPMENT PERMIT**

REVISIONS:

DATE DESCRIPTION

SHEET TITLE: **TYPICAL SECTIONS**

DRAWN BY: CHECKED BY: DATE CREATED: AX/SY 7/28/23

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GENERAL SHEET NOTES

1. INSTALL AND MAINTAIN INLET PROTECTION

ON ALL STORM INLETS 100' FROM SITE.

2. ALL EXISTING TREES WILL BE REMOVED

4. PER CITY OF BEAVERTON'S INVENTORIES, THE SITE DOES NOT INCLUDE NATURAL RESOURCE AREAS, SIGNIFICANT TREES,

PER CLEAN WATER SERVICES STANDARDS, THE SITE IS NOT WITHIN SENSITIVE AREAS.

AREA BOUNDARIES, ROCK OUTCROPPINGS,

DESCRIPTION

EXISTING CONTOUR

PROPOSED CONTOUR

REMOVE EXISTING TREE

SLOPE ARROW

AND STREAMS FALL WITHIN THE SITE

NO WETLAND BOUNDARIES, UPLAND WOODED AREA BOUNDARIES, RIPARIAN

3. SITE IS NOT LOCATED WITHIN THE

100-YEAR FLOODPLAIN.

AND HISTORIC TREES.

LEGEND

SYMBOL

----610 -----

----610 -----

▼ X.X%

ABBREVIATIONS

(E) EXISTING

FF FINISH FLOOR

FG FINISH GRADE

G GUTTER GRADE

TC TOP OF CURB

TP TOP OF PAVEMENT/SIDEWALK

NORTH ARROW + SCALE BAR

GRAPHIC SCALE

1 inch = 20 ft.

BS BOTTOM OF STAIR

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EXPIRES 12-31-2024 **PUBLIC PLANS**

REVISIONS:

#\ DATE DESCRIPTION


GRADING PLAN

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7/28/23



LEG 210.49

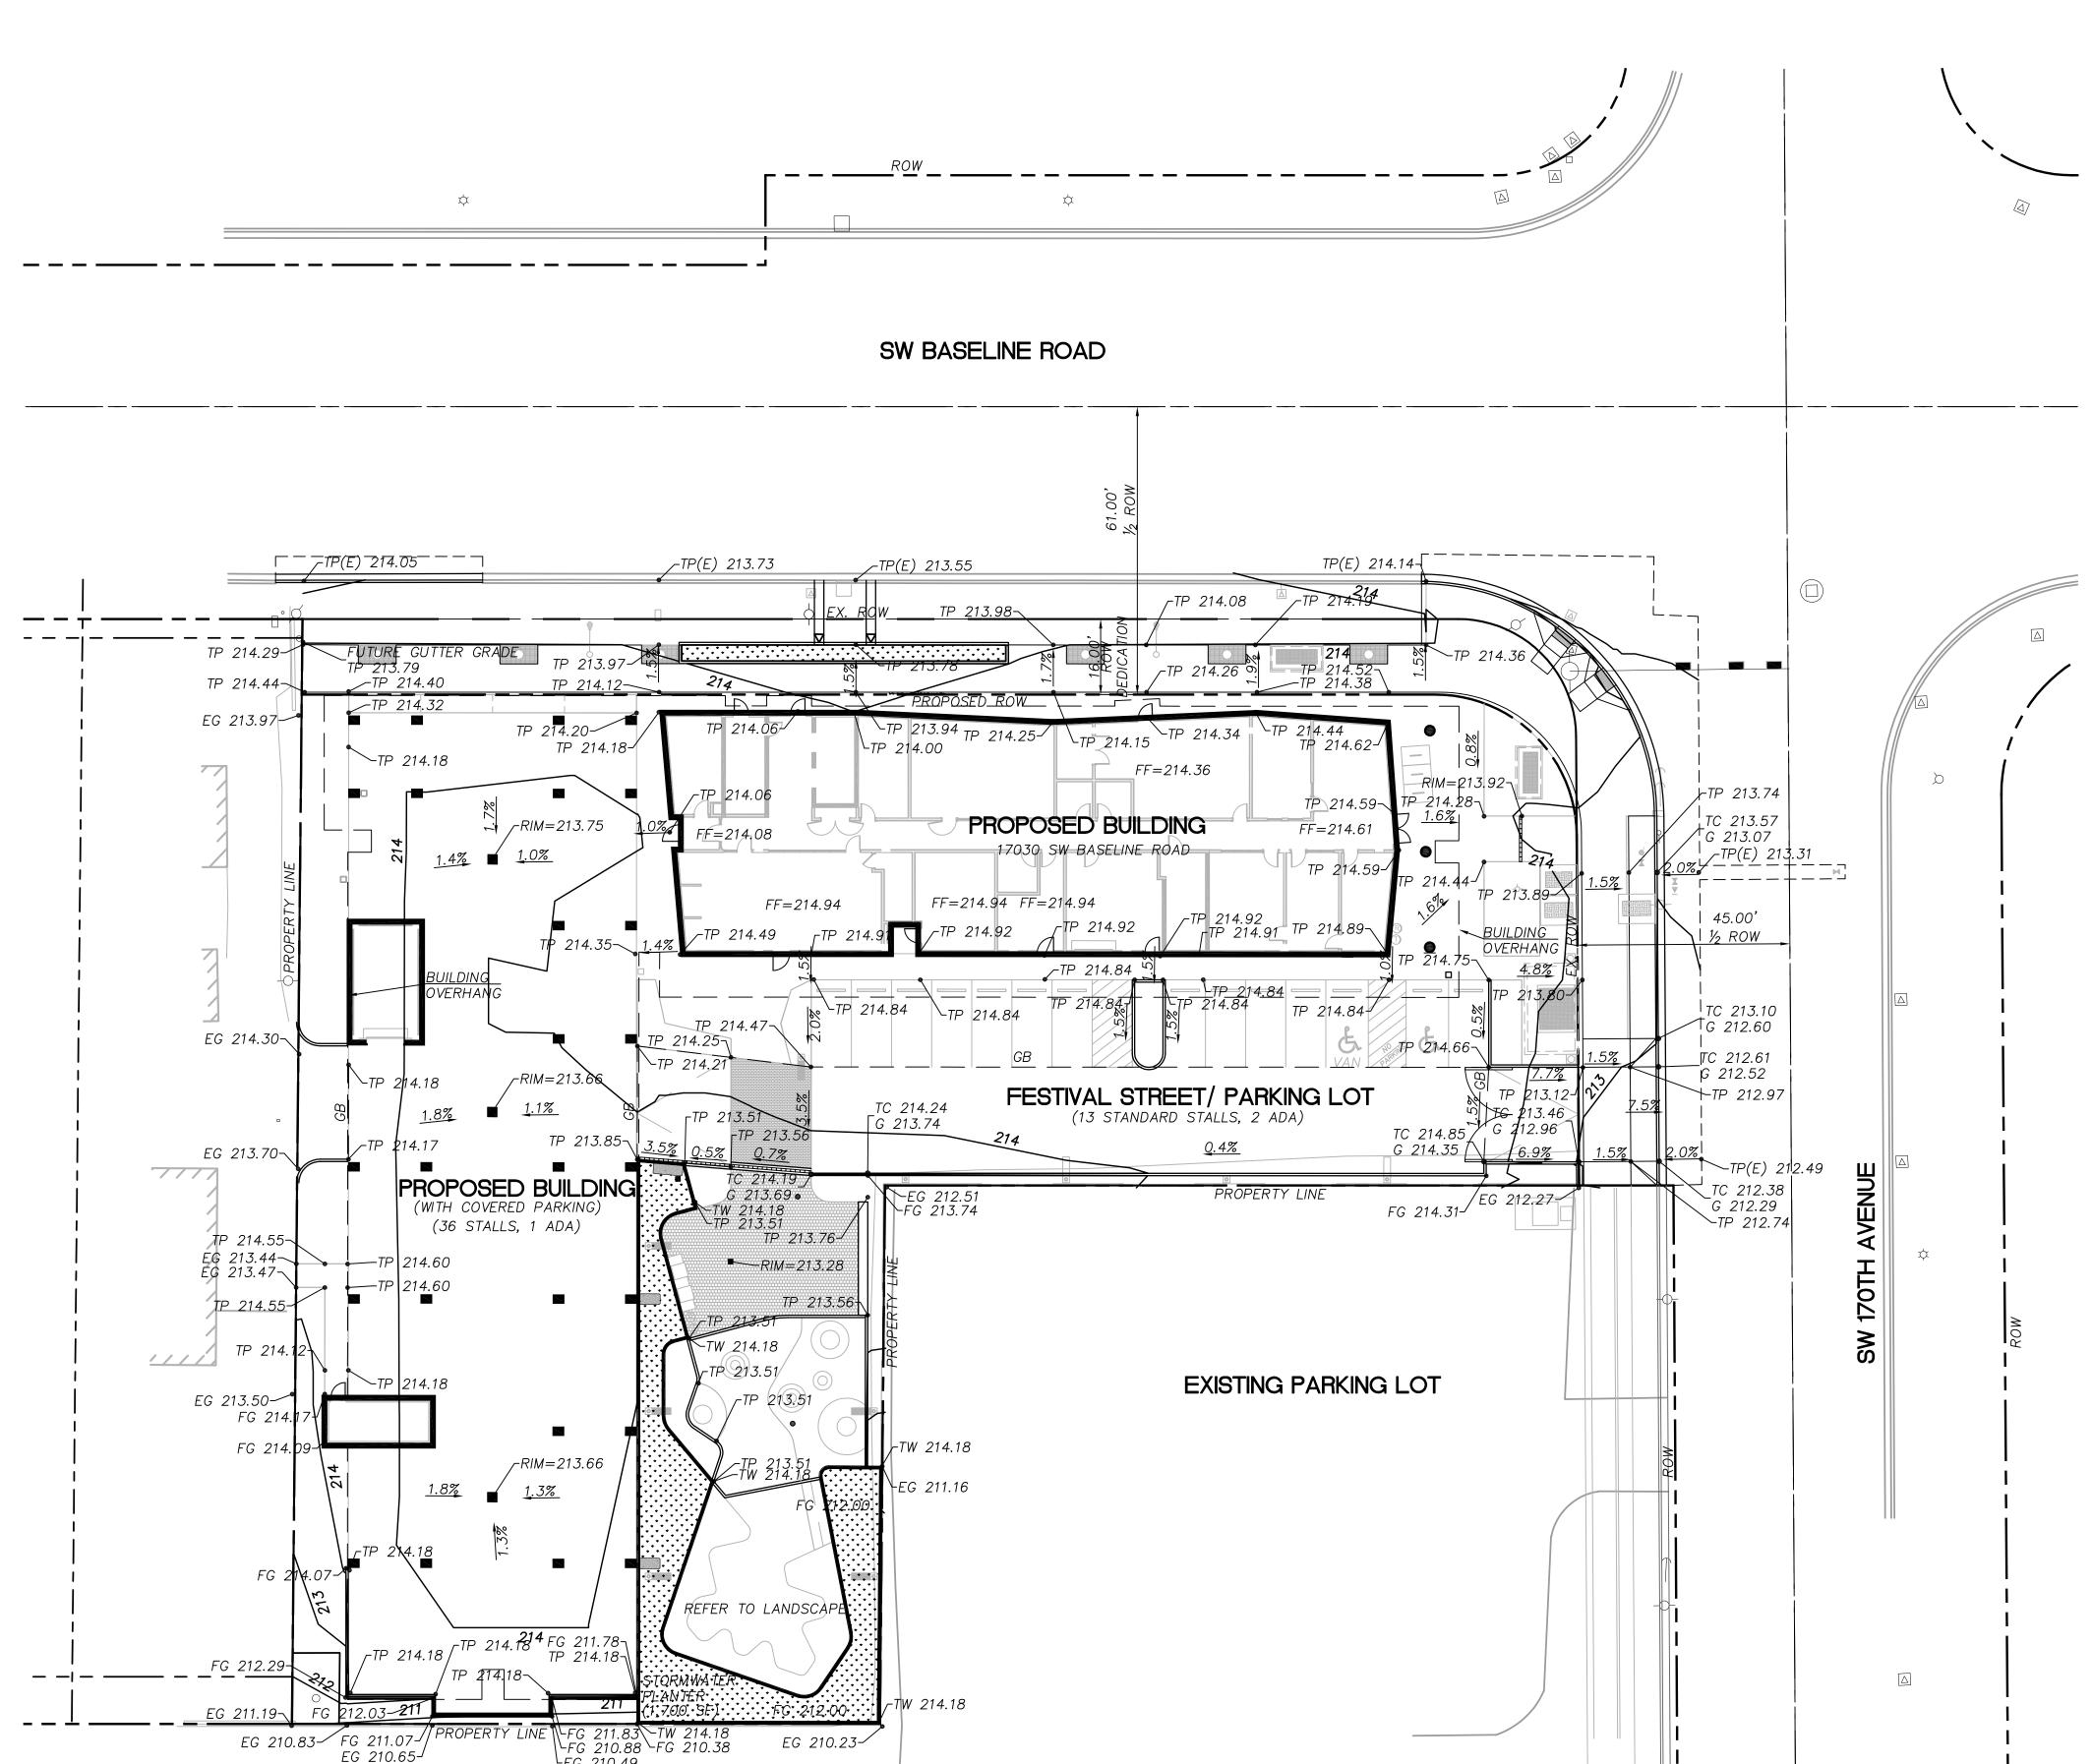

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SAL

PROJECT NUMBER: **ELMONICA**

STATION

17030 SW BASELINE ROAD

BEAVERTON, OR 97006

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EXPIRES 12-31-2024

PUBLIC PLANS

REVISIONS:

∠#\ DATE DESCRIPTION

SHEET TITLE: UTILITY **PLAN**


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AX/SY

7/28/23

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SCALE: 1"=20'

- ALL OVERHEAD UTILITIES TO BE UNDERGROUNDED ALONG SW BASELINE AND SW 170TH AVE PER CITY OF BEAVERTON REQUIREMENTS.
- 2. ROUTE ALL ROOF DRAINS TO STORMWATER PLANTER.
- 3. FOUNDATION DRAIN TO BE INSTALLED ALONG PERIMETER OF EACH BUILDING.
- 4. SITE IS NOT LOCATED WITHIN THE 100-YEAR FLOODPLAIN.
- 5. PER CITY OF BEAVERTON'S INVENTORIES. THE SITE DOES NOT INCLUDE NATURAL RESOURCE AREAS, SIGNIFICANT TREES, AND HISTORIC TREES.
- 6. PER CLEAN WATER SERVICES SERVICE PROVIDER LETTER, THE SITE IS NOT WITHIN SENSITIVE AREAS.
- NO WETLAND BOUNDARIES, UPLAND WOODED AREA BOUNDARIES, RIPARIAN AREA BOUNDARIES, ROCK OUTCROPPINGS, AND STREAMS FALL WITHIN THE SITE AREA

LEGEND		
SYMBOL	DESCRIPTION	
SD	PROPOSED STORM DRAIN	(X) (Cxxx)
SS	PROPOSED SANITARY DRAIN	
W	PROPOSED WATER	
FS	PROPOSED FIRE WATER	
G	PROPOSED	

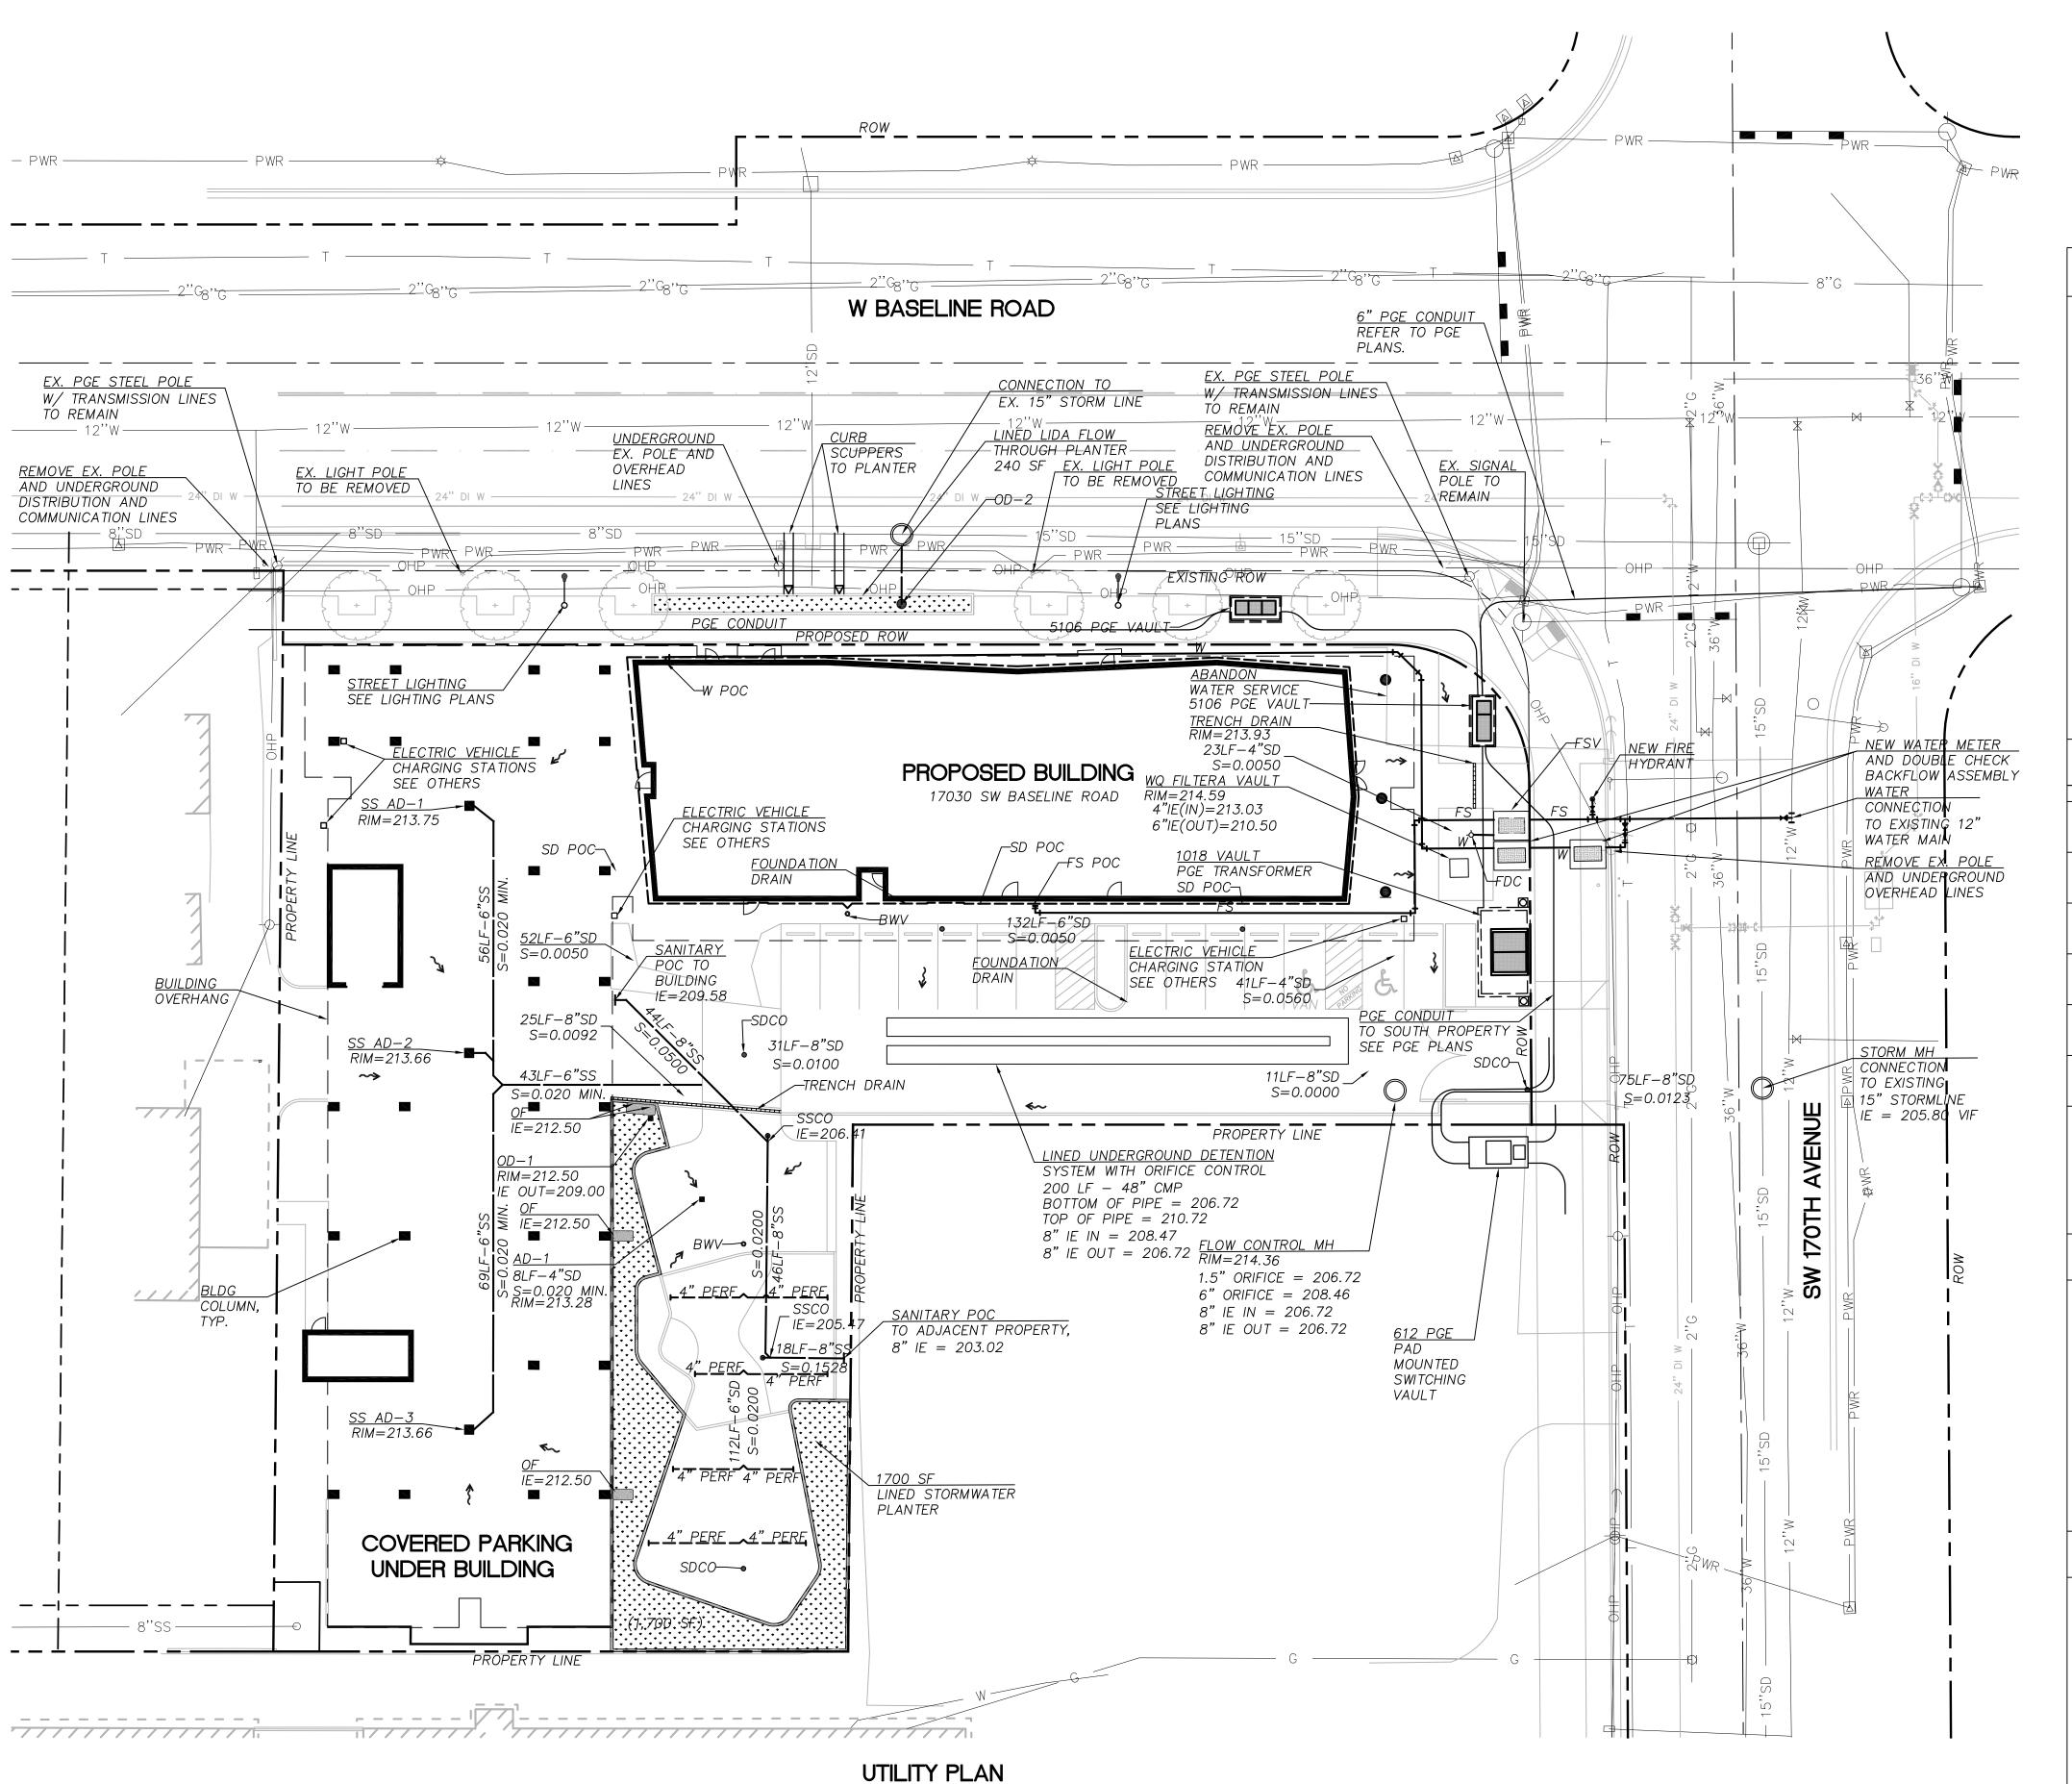GAS


FLOW


DIRECTION

ABBREVIATIONS

- SANITARY SEWER STORM DRAIN GAS
- WATER FS FIRE SERVICE

NORTH ARROW + SCALE BAR

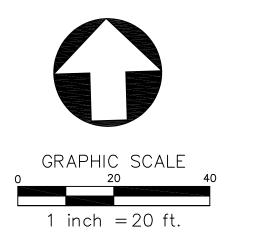

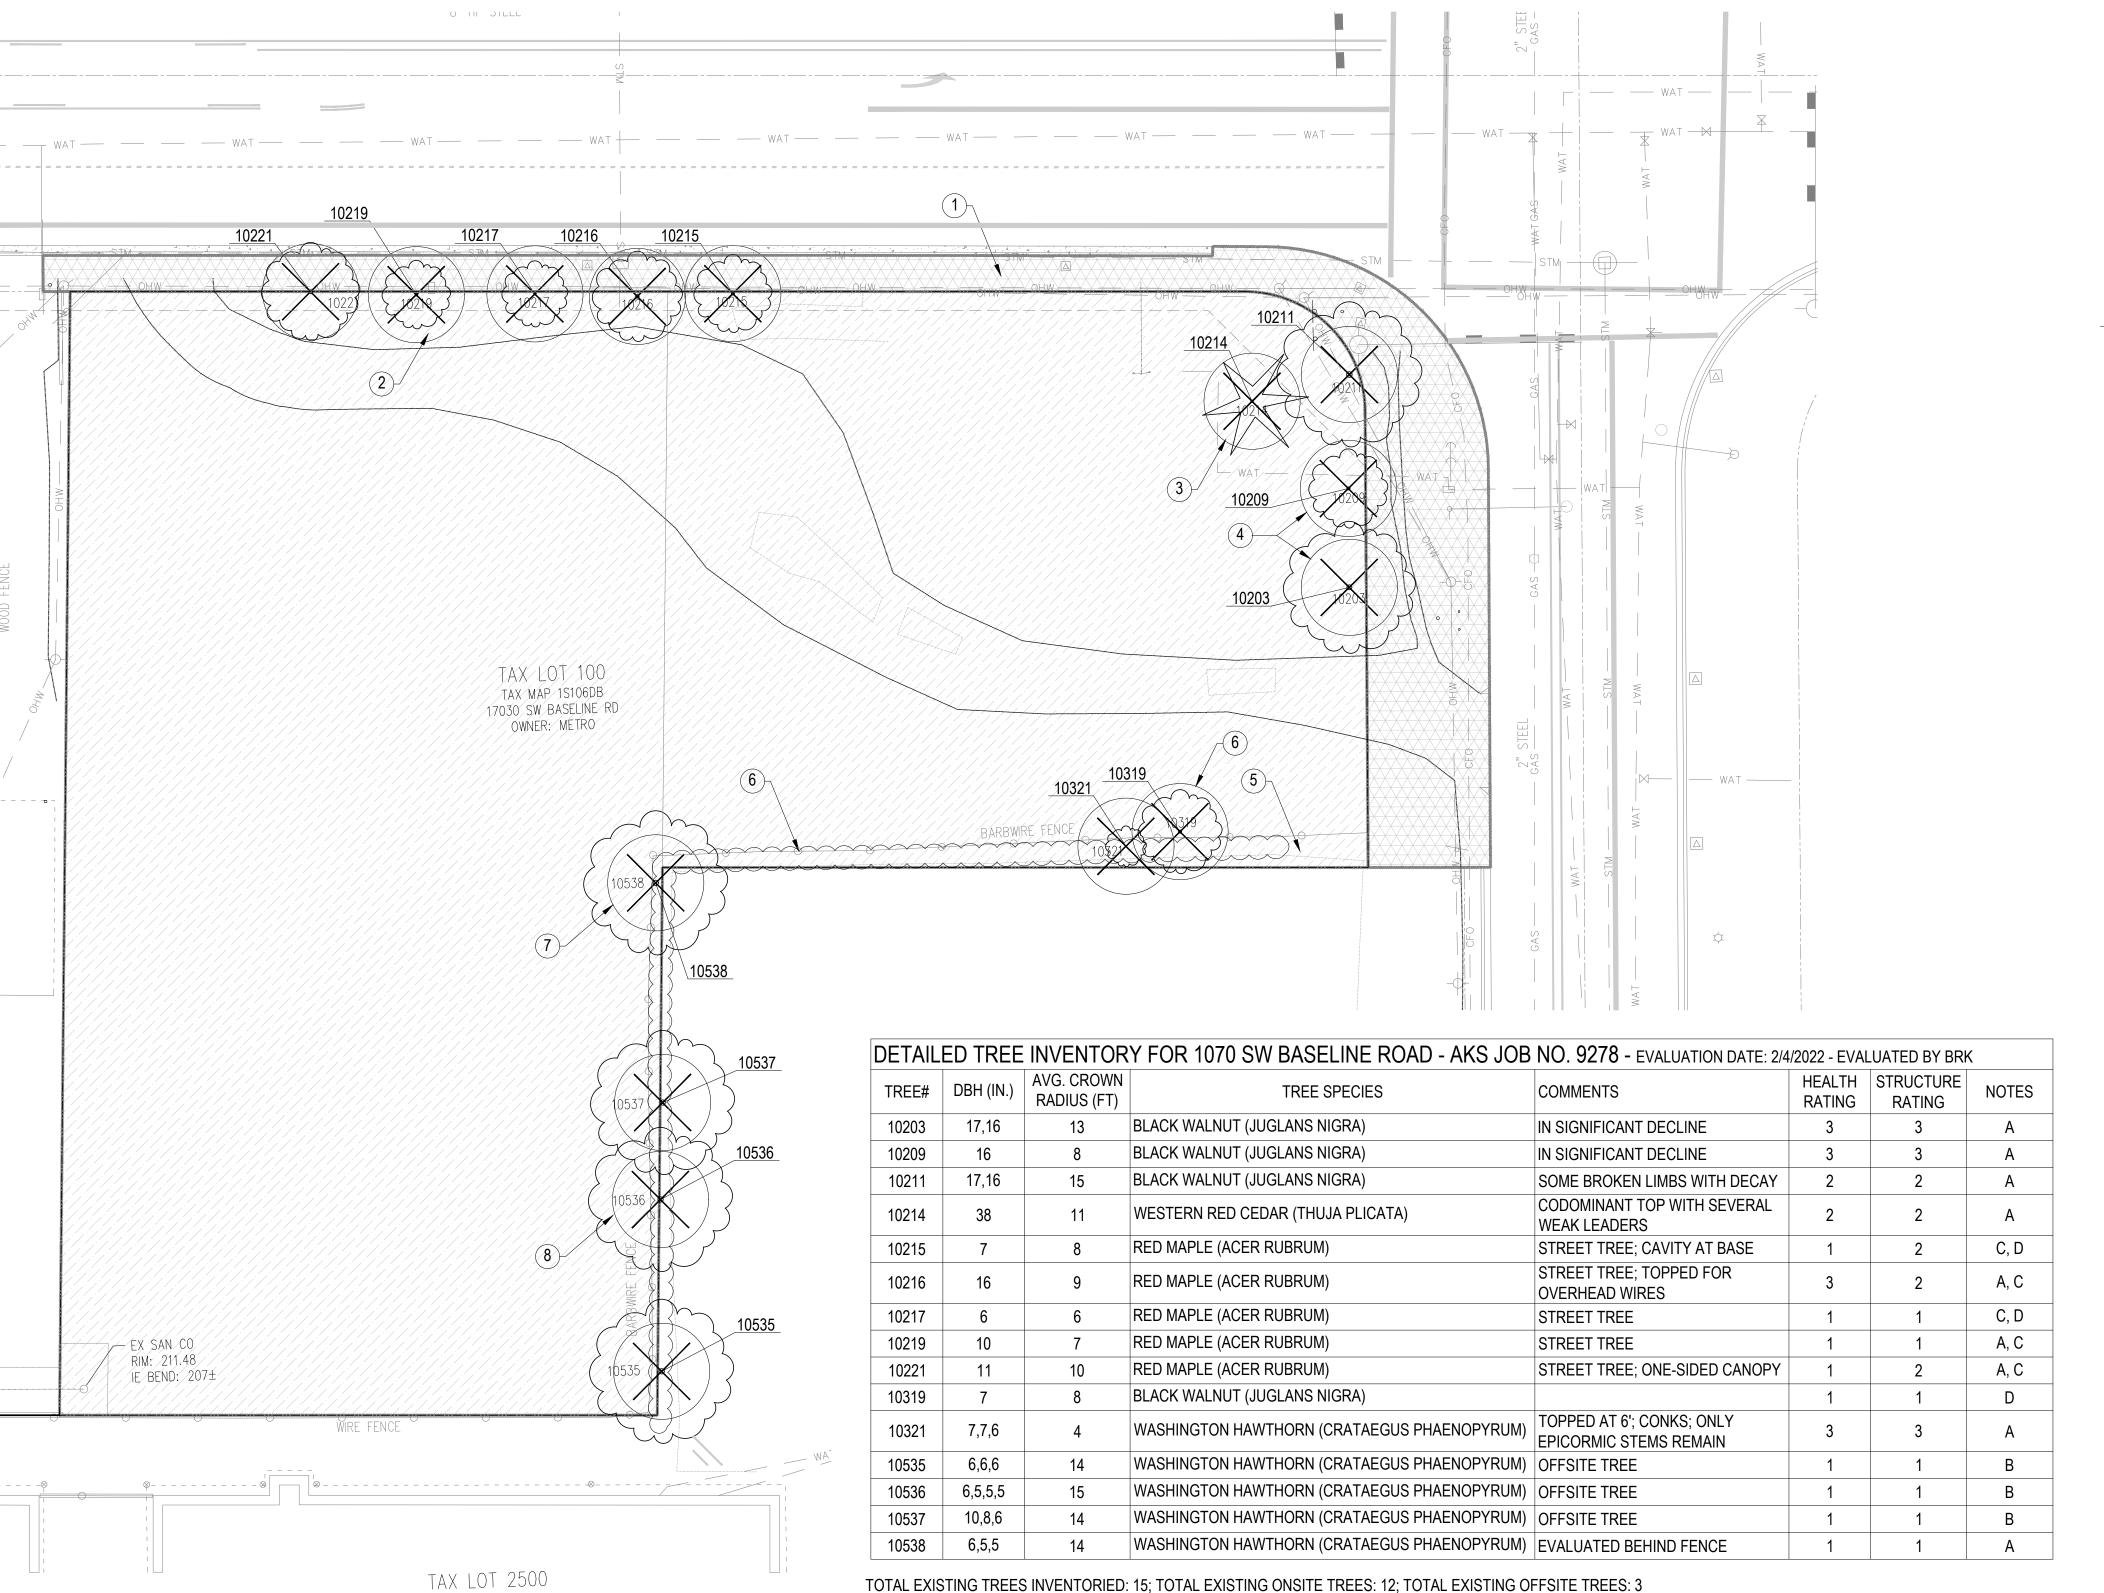

TREE REMOVAL PLAN

HEALTH RATING:

1 = GOOD HEALTH; 2 = FAIR HEALTH; 3 = POOR HEALTH

STRUCTURE RATING:

1 = GOOD STRUCTURE; 2 = FAIR STRUCTURE; 3 - POOR STRUCTURE

NOTES LEGEND:

A= ON-SITE COMMUNITY TREE (10" DBH or Larger); B= OFF-SITE COMMUNITY TREE; C= STREET TREE; D= EXEMPT TREE

Arborist Disclosure Statement:

Arborists are tree specialists who use their education, knowledge, training, and experience to examine trees, recommend measures to enhance the health of trees, and attempt to reduce the risk of living near trees. The Client and Jurisdiction may choose to accept or disregard the recommendations of the arborist, or seek additional advice. Arborists cannot detect every condition that could possibly lead to the structural failure of a tree. Trees are living organisms that fail in ways we do not fully understand. Conditions are often hidden within trees and below ground. Arborists cannot guarantee that a tree will be healthy or safe under all circumstances, or for a specified period of time. Likewise, remedial treatments, like medicine, cannot be guaranteed. Trees can be managed, but they cannot be controlled. To live near trees is to accept some degree of risk. The only way to eliminate all risk associated with trees is to eliminate all trees. Neither this author nor AKS Engineering & Forestry, LLC have assumed any responsibility for liability associated with the trees on or adjacent to this site.

DEMOLITION SCHEDULE

CLEAR AND GRUB - ON SITE

CLEARING AND DEMOLITION LIMITS REMOVE EVERYTHING WITHIN THIS AREA UNLESS OTHERWISE NOTED. REMOVE ALL IMPROVEMENTS; CLEAR AND GRUB TO UNIFORM DEPTH OF 6" IN PAVED AREAS, 4"

IN NON-PAVED AREAS.

RIGHT-OF-WAY DEMOLITION AREA

TREE TO BE REMOVED

XXXX= TREE I.D. NUMBER PER SURVEY

NOTES

- 1. REFER TO CIVIL DRAWINGS FOR DEMOLITION AND UTILITY COORDINATION.
- REFER TO CIVIL DRAWINGS FOR RIGHT-OF-WAY SCOPE OF WORK THIS DRAWING IS BASED ON SURVEY INFORMATION PROVIDED BY AKS ENGINEERS DATED 2 / 22 / 2022.
- REFERENCED ARBORIST EVALUATION AND TREE INVENTORY BY AKS ENGINEERING AND FORESTRY, BENNETT R. KOCSIS CERTIFIED ARBORIST #PH 997A

KEY NOTES

- DIAGRAMMATIC PLAN SHOWING EXTENT OF SITE VS. RIGHT-OF-WAY CLEAR AND GRUB AREAS; REFER TO CIVIL DRAWINGS FOR SPECIFICS ON DEDICATIONS, DEMOLITION PLANS AND ADDITIONAL NOTES.
- EXISTING STREET TREES WILL BE REMOVED DUE TO THE RIGHT-OF-WAY EXPANSION AT WEST BASELINE ROAD.
- EXISTING WESTERN RED CEDAR AT CORNER WILL BE IN CONFLICT WITH THE BUILDING STRUCTURE AND PLAZA.
- THE TWO SMALLER EXISTING WALNUT TREES (10209 & 10203) ARE IN POOR CONDITION AND DO NOT HAVE SIGNIFICANT VISUAL OR ENVIRONMENTAL VALUE; TREE 10211 IS IN BETTER CONDITION, HOWEVER IT WILL BE IN CONFLICT WITH FUTURE MODIFICATIONS TO THE RIGHT-OF-WAY, SIGHT LINES AND UTILITIES.
- EXISTING INVASIVE SPECIES OBSERVED, SPREADING INTO EXISTING HEDGE AND TREES. TO BE REMOVED AND ERADICATED.
- EXISTING TREES 10319 & 10321 ARE EMBEDDED IN OVERGROWN ARBORVITAE HEDGE, WHICH NEEDS TO BE REMOVED TO CLARIFY BOUNDARIES BETWEEN PROPERTIES.
- EXISTING TREE 10538 IS IMMEDIATELY ADJACENT TO THE PROPERTY LINE. WHERE A FENCE AND DELINEATION OF THE PROPERTY NEEDS TO OCCUR.
- EXISTING TREES 10537, 10536 & 10535 ARE LOCATED IN NEIGHBORING PROPERTY: OWNER REPRESENTATIVE FOR THE ADJACENT PROPERTY PROJECT HAS INDICATED THAT THE TREES MAY BE REMOVED DUE TO IMPACTS FROM IMPROVEMENTS TO BOTH PROJECTS.

SUITE 240 PORTLAND, OR 97202

3050 SE DIVISION ST.

PHONE: 503.702.2575

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PROJECT NUMBER:

ELMONICA STATION

17030 SW BASELINE ROAD BEAVERTON, OR 97006

CLIENT:

REACH CDC

4150 S MOODY AVE PORTLAND, OR 97239

PLACE PORTLAND, OR 97209

PLANNING COMMISSION SET

REVISIONS:

/#**** DATE

DESCRIPTION


SHEET TITLE: TREE REMOVAL **PLAN**


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07/25/23

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MATERIALS LEGEND

------- PROPERTY LINE

TYP. **TYPICAL**

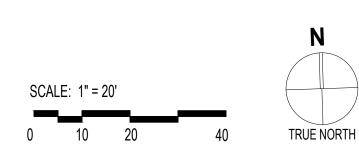MATERIALS SCHEDULE

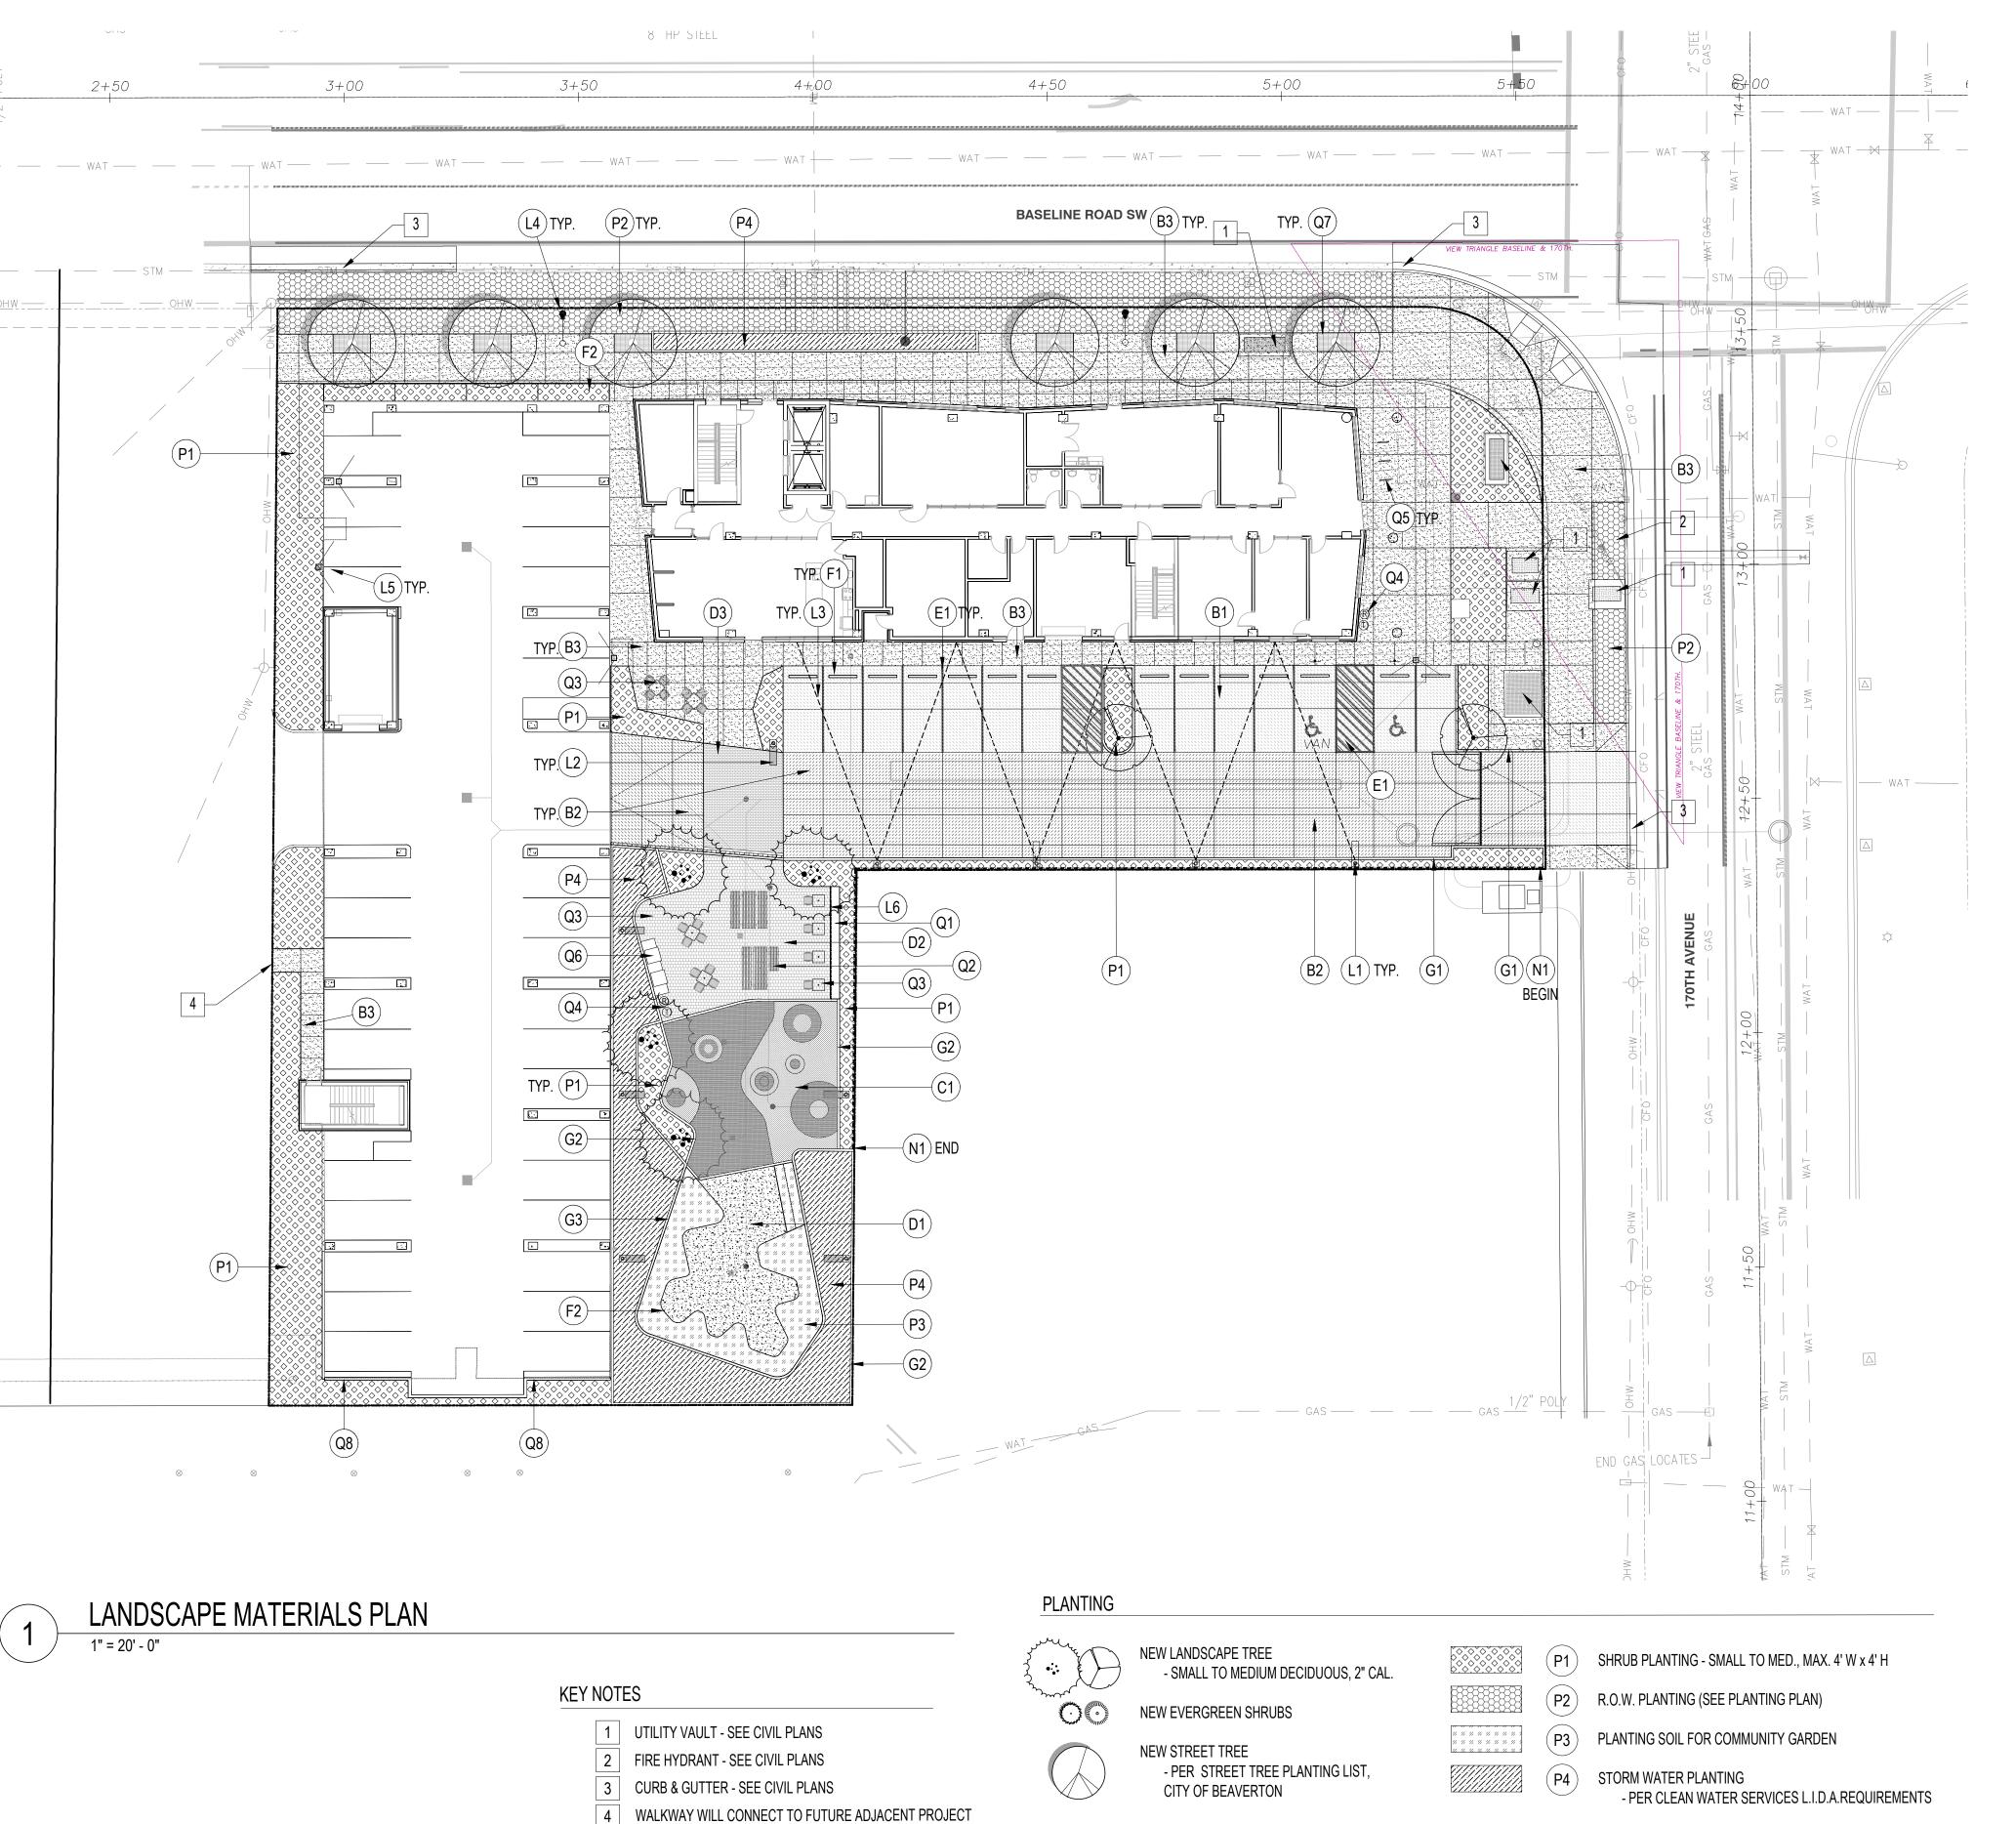PAVEMENTS

ASPHALT PAVING - VEHICULAR (SEE CIVIL)

DECORATIVE CONCRETE PAVING - VEHICULAR TYPE 1 - HEAVY BROOM FINISH FOR PED-CROSSING, PARKING STALLS

DECORATIVE CONCRETE PAVING - VEHICULAR TYPE 2 - EXPOSED AGG. FOR DRIVE AISLE ZONE

CONCRETE PAVING - PEDESTRIAN - MED. BROOM FINISH, SEE CIVIL FOR ROW WORK

> RUBBERIZED PLAY SURFACING AND 24"-30" HT. MOUNDS - PEBBLEFLEX OR SIM.; 3 COLORS MAX.

CRUSHED STONE WALK AT COMMUNITY GARDEN - CRUSHED BASALT, 1/4 INCH-0 w/ FINES

CONCRETE UNIT PAVING TYPE 1: PEDESTRIAN - WILLAMETTE GRAYSTONE CITY STONE V SERIES - 8x8" INTERLOCKING PAVERS, 2" THICKNESS

CONCRETE UNIT PAVING TYPE 2: VEHICULAR - WILLAMETTE GRAYSTONE CITY STONE V SERIES - 4x8" INTERLOCKING PAVERS, 4" THICKNESS

PARKING STRIPING (SEE CIVIL)

PARKING STALL WHEEL STOP (SEE CIVIL)

FABRICATED METAL PLANTER - SHEET METAL, 24" HT, RUSTED FINISH

STAIRS, RAMPS, CURBS AND WALLS

CONCRETE CURB - RAISED

CONCRETE CURB - FLUSH (6" BAND, 6"-12" DEPTH)

STORM WATER PLANTER WALL

OUTDOOR LIGHTING - SEE ELECTRICAL

LIGHT POLE - TYPE 1 - PARKING - SEE ELECTRICAL

LIGHT POLE - TYPE 2 - CENTRAL SPACE 0 - SEE ELECTRICAL

'FESTIVAL STREET' STRING LIGHTING & POLES - SEE ELECTRICAL

STREET LIGHTING (SEE CIVIL)

ELECTRIC VEHICLE CHARGING STATIONS - SEE ELECTRICAL, CIVIL

LINEAR LED LIGHT AT C.I.P. CONCRETE BENCH

RAILINGS, GATES, AND FENCES

4' WOOD FENCE ("GOOD NEIGHBOR")

SITE FURNISHINGS

C.I.P. CONCRETE BENCH w/ LINEAR LED



PICNIC TABLE - FORMS + SURFACES - TYPE 1: VECTOR SYSTEM 6 TABLE ENSEMBLE - TYPE 2: VECTOR SYSTEM 6 TABLE ENSEMBLE, ADA OPTION

(Q3)TABLE & CHAIRS - LANDSCAPE FORMS


> LITTER/RECYCLING - FORMS + SURFACES - TONYO 36 GAL. SPLIT STREAM W/RAIN HAT - STAINLESS STEEL BODY & DOORS, SOLID PANELS

BIKE RACK - COLUMBIA CASCADE COMPANY - TIMBERFORM CYCLOOPS MODEL NO. 2170-3-06

(Q6) OUTDOOR GRILL & COUNTER. TBD.

> TREE GRATE AT STREET TREE WELLS - URBAN ACCESSORIES - KIVA RTC

WALL TRELLIS FOR VERTICAL PLANTING

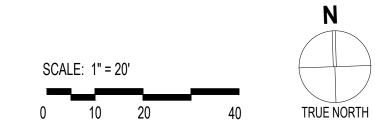

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S

CLIENT:

PROJECT NUMBER:

ELMONICA STATION

17030 SW BASELINE ROAD BEAVERTON, OR 97006

REACH CDC

4150 S MOODY AVE PORTLAND, OR 97239

PLACE PORTLAND, OR 97209

(503) 334 2080 PHASE:

PLANNING COMMISSION SET

REVISIONS:

DATE DESCRIPTION

MATERIALS PLAN

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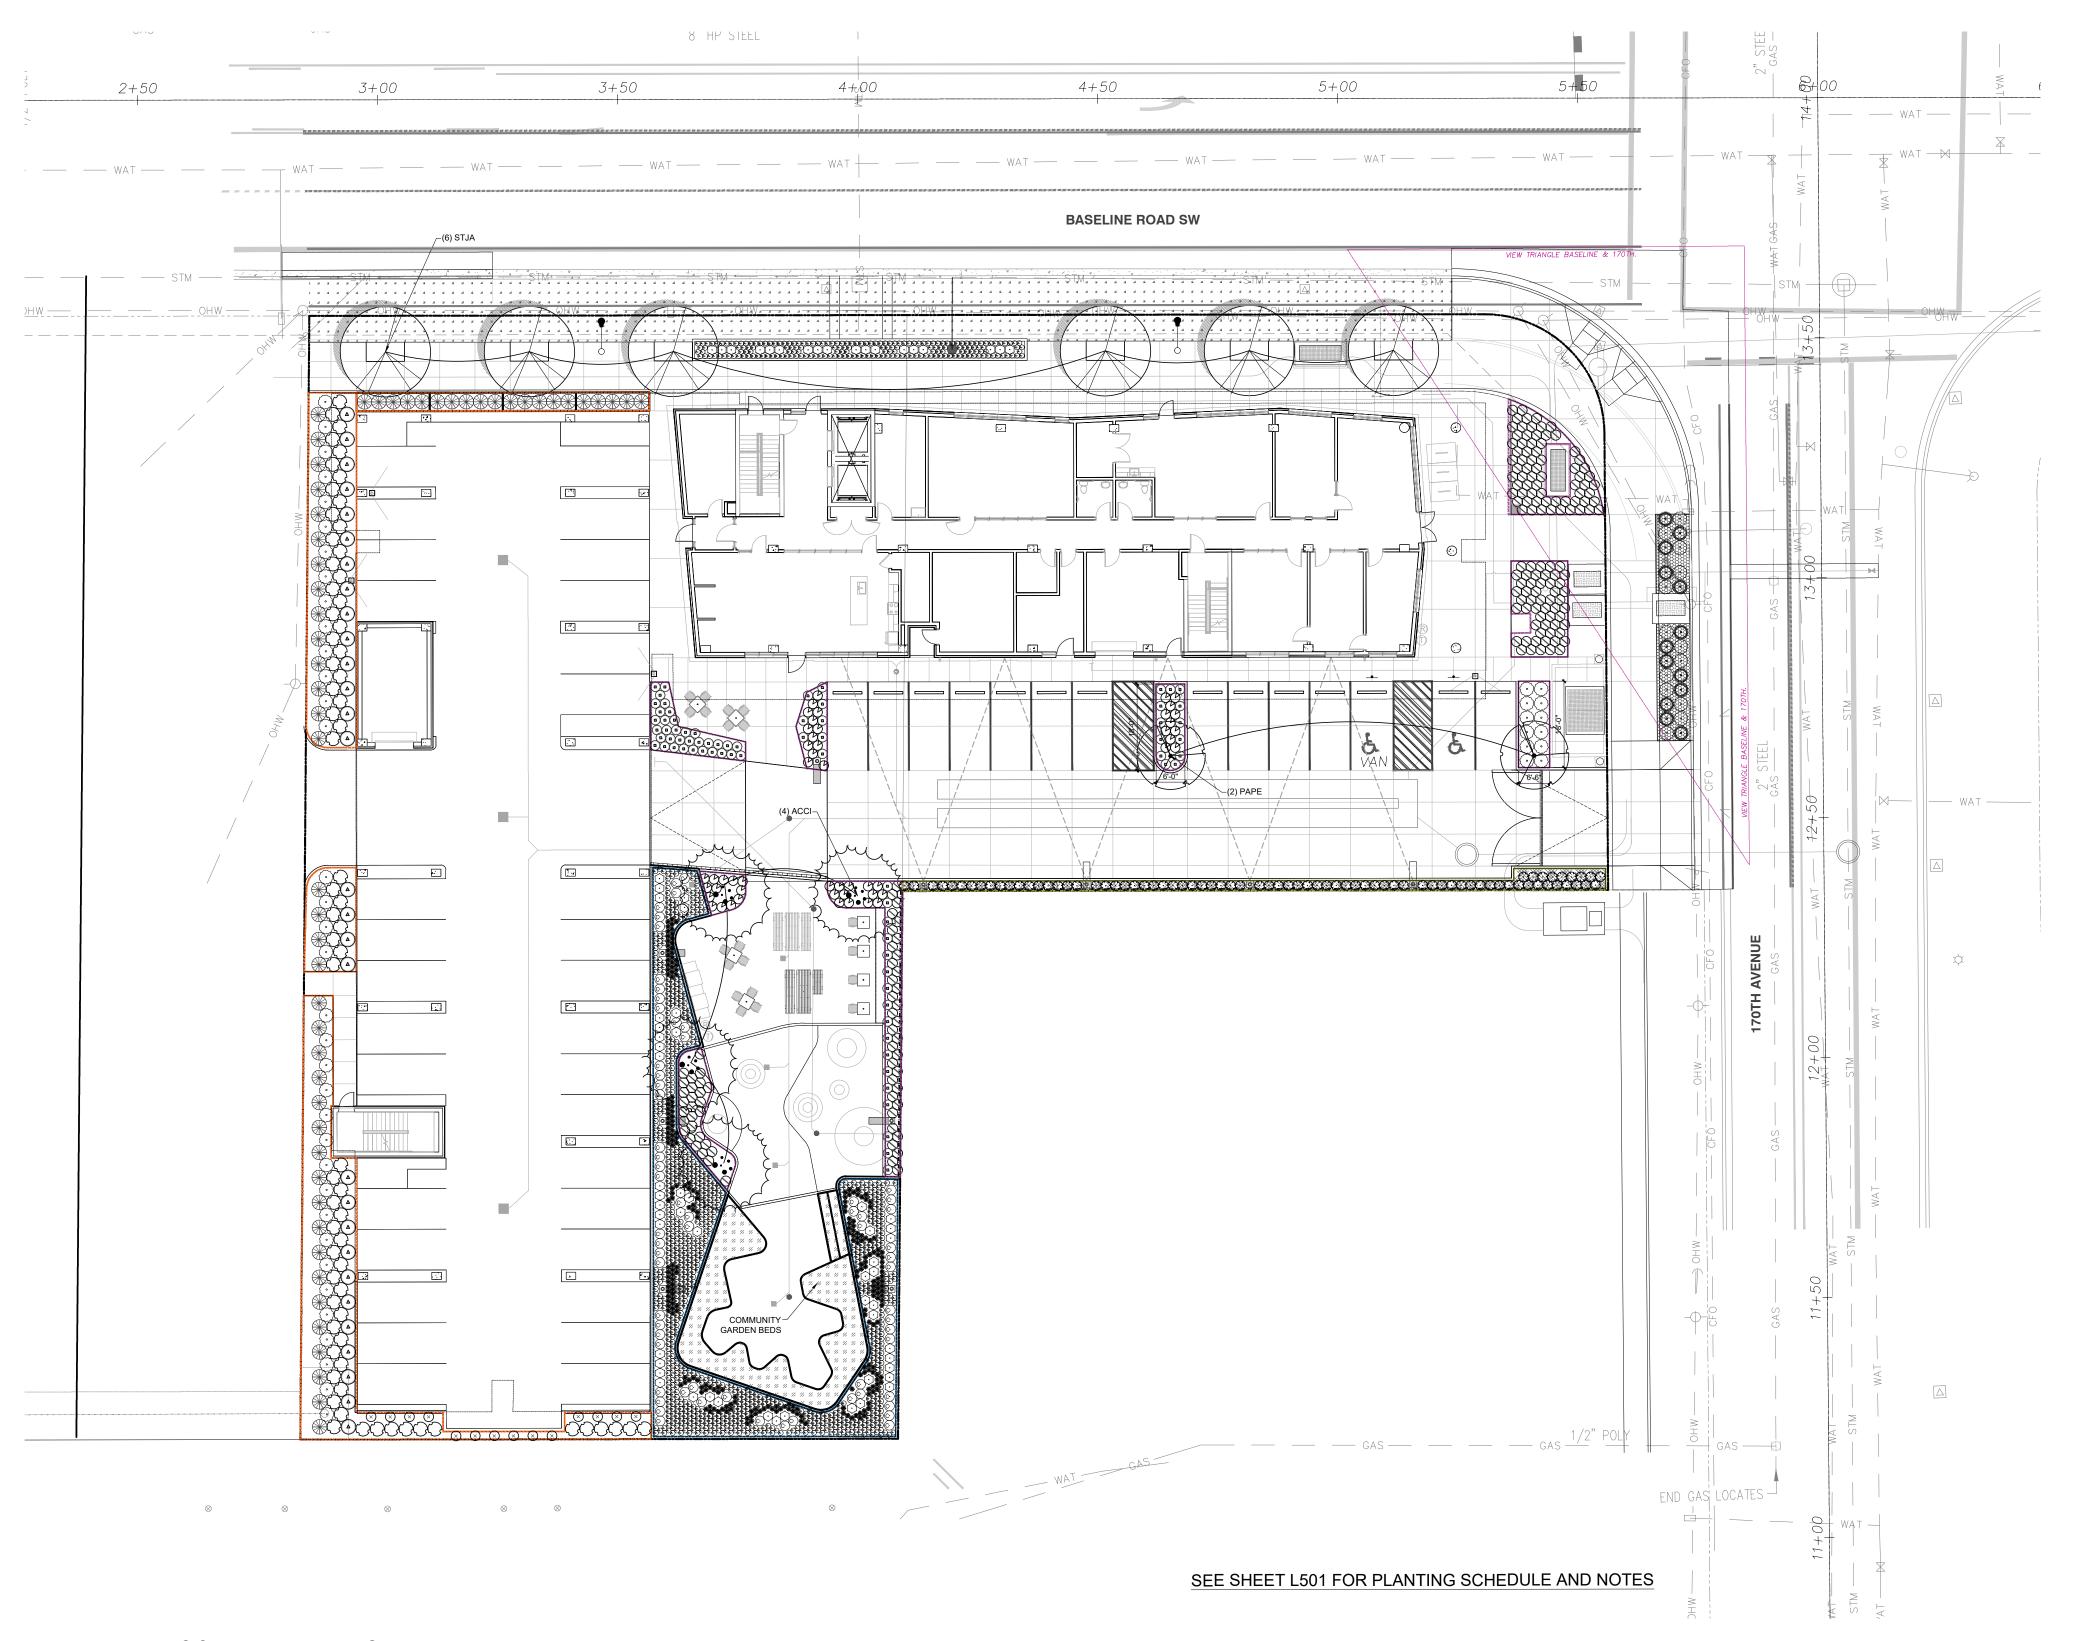
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ALTHOUGH 60.05.25.3 HAS A MINIMUM LANDSCAPE AREA REQUIREMENT OF 15% OF GROSS SITE AREA, WE ARE PURSUING GUIDELINE 60.05.45.1.A-D

LANDSCAPE AREAS PROVIDED FOR REFERENCE ONLY:

PLANTING AT GARAGE PERIMETER





STORM WATER PLANTER AREA



BUFFER & SCREEN BETWEEN PARKING & NEIGHBOR

TOTAL

B) 60.05.25.4 E - MINIMUM PLANTING REQUIREMENTS

(1) TREE FOR EVERY (800) SF OF REQ. LANDSCAPE AREA

6,322 / 800 = 7.9 = 8 TREES

PROVIDED: (4) ACCI & (2) PAPE.

(1) EVERGREEN SHRUB MIN. MATURE HT 48" FOR EVERY

6,322 / 400 = 15.8 = 16 SHRUBS

PROVIDED: (191) CETH; (76) GASH; (33) CIPU; (36) MAAQ & (55) POMU

LIVE GROUND COVER (LOW HEIGHT PLANTS, SHRUBS OR GRASS) IN PORTIONS OF LANDSCAPE AREAS NOT OCCUPIED BY TREES OR EVERGREEN SHRUBS; GRAVEL & MINERAL MULCH MAY BE USED BUT LIMITED TO NO

PROVIDED: SHRUBS, GRASSES, GROUND COVERS AND

LAND USE AREA SUMMARY:

2,331.2 SF



PLANTING AT PARKING, OUTDOOR AMENITY & PLAZA



347.1 SF

5,860.2 SF

(PURSUING GUIDELINE 60.05.45.1.A-D)

SEE PLANTING SCHEDULE

(400) SF OF REQ. LANDSCAPE AREA

MORE THAN 25% OF THE REQUIRED LANDSCAPE AREA

VINES THROUGHOUT

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PLANTING PLAN

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TRUE NORTH

LANDSCAPE PLANTING PLAN

	PLANT S	CHEDULE						
	SYMBOL	KEY	BOTANICAL NAME	COMMON NAME	CONT . SIZE	SPACING	QTY. & TYPE	SIZE AT MATURITY
	BARBEQ	JE AREA, F	PLAY AREA, PARKING AND PLAZ	ZA AREA	T			
-		CETH	CEANOTHUS THRYSIFLORUS	BLUE BLOSSOM	#1	2' O.C.	(189 CT.) E	4-12' HT
4		GASH	GAULTHERIA SHALLON	SALAL	#1	2' O.C.	(72 CT.) E	4' HT
4		OXOR	OXALIS OREGANA	REDWOOD SORREL	#1	2' O.C.	(78 CT.) E	4" HT (G.COVER)
+		SPSP	SPIRAEA SPLENDENS	MOUNTAIN SPIRAEA	#1	2' O.C.	(50 CT.) D	3'-4' HT
	GARAGE	PERIMETE	R PLANTING MIX		•			
#	Δ	CIPU	CISTUS X PURPUREUS	ROCKROSE	#2	3' O.C.	(33 CT.) E	4' HT
#	\bigcirc	COSE	CORNUS SERICEA 'KELSEYI'	KELSEY RED TWIG DOGWOOD	#3	3' O.C.	(78 CT.) D	2.5' HT
+		MAAQ	MAHONIA AQUIFOLIUM 'COMPACTA'	COMPACT OREGON GRAPE	#3	3' O.C.	(47 CT.) E	3' HT
*		POMU	POLYSTICHUM MUNITUM	WESTERN SWORD FERN	#3	3' O.C.	(55 CT.) E	4' HT
	BASELINI	RD. TEMI	PORARY SEEDED LAWN MIX (1-	-2 LBS PER 1000 SQ FT)	-	1		
	7 7 7 7 7 7 7 7		LOLIUM PERENNE	KARMA PERENNIAL RYEGRASS	-	-	-	
			FESTUCA TRACHYPHYLLA	EUREKA II HARD FESCUE	-	-	-	
	7 7 7 7 7 7 7 7 7 7 7 7 7 7 7 7 7 7 7		FESTUCA OVINA 'QUATRO'	QUATRO TETRAPLOID SHEEP FESCUE	-	-	-	
	7 7 7 7 7 7 7 7		ACHILLEA MILLEFOLIUM	WHITE YARROW	-	-	-	
	7 7 7 7 7 7 7 7	SEMX	TRIFOLIUM REPENS	WHITE CLOVER	-	-	-	
	7 7 7 7 7 7 7 7		BELLIS PERENNIS	ENGLISH DAISY	-	-	-	
	1 1 1 1 1 1 1 1 1 1 1 1 1 1 1 1 1 1 1		LOBULARIA MARITIMA	SWEET ASYLUM	-	-	-	
	7 7 7 7	NEMOPHILA MENZIESSII		BABY BLUE EYES	-	-	-	
	7 7 7 7		TRIFOLIUM FRAGIFERUM	STRAWVERRY CLOVER	-	-	-	
	RIGHT-O	-WAY PLA	NTING			1		
#		FRCH	FRAGARIA CHILOENSIS	BEACH STRAWBERRY	SP4	12" O.C.	(342 CT.) E	GROUNDCOVER AT 170TH
*	(°)	MAAQ	MAHONIA AQUIFOLIUM 'COMPACTA'	COMPACT OREGON GRAPE	#3	3' O.C.	(13 CT.) E	3' HT AT 170TH & EAST PARKING EDGE
	STORMW	ATER MIX	(ZONE A)					
+	(C)	CADE	CAREX DENSA	DENSE HEDGE	#1	12" O.C.		
*	₽	CAOB	CAREX OBNUPTA	SLOUGH HEDGE	#1	12" O.C.		
*	(·)	DECA	DESCHAMPSIA CESPITOSA	TUFTED HAIR GRASS	#3	2' O.C.		PRIVATE FACILITY ONLY
*	*	IRDO	IRIS DOUGLASIANA	DOUGLAS IRIS	#1	12' O.C.		PRIVATE FACILITY ONLY
						+		+

NOTE: THESE ARE PRELIMINARY FOR LAND USE. STORMWATER PLANTERS FINAL PLANTING SELECTIONS WILL BE REFINED FOR PERMIT SUBMISSION PER CLEAN WATER SERVICES' LIDA HANDBOOK AND APPROVED PLANTING LISTS.

#1 2' O.C.

SPREADING RUSH

	CLIMBING VINES (SOUTH GARAGE WALL)										
#	\otimes	LOHE	LONICERA X HECKROTII	GOLD FLAME HONEYSUCKLE	#2	4' O.C.	(14 CT.) D	10-15' HT			
	MISC.			AREA							
			BARK MULCH	347 SF							
			COMMUNITY GARDEN BEDS		627 SF						


★ INDICATES NATIVE / NATURALIZED SPECIES IN OREGON.

JUNCUS PATENS

INDICATES ADAPTIVE SPECIES (THRIVES IN THE REGION, LOW WATER USE ONCE ESTABLISHED) TYPE: E = EVERGREEN D = DECIDUOUS

PLANTING NOTES

- 1. VERIFY AND COORDINATE WORK AROUND ALL UNDERGROUND UTILITIES BEFORE EXCAVATION. NOTIFY ALL UTILITY PROVIDERS AT LEAST TWO (2) WORKING DAYS PRIOR TO BEGINNING WORK.
- 2. VERIFY THAT THE CONDITIONS ARE SUITABLE TO PROMOTE HEALTHY PLANT GROWTH. DO NOT PROCEED IF CONDITIONS DETRIMENTAL TO HEALTHY GROWING ENVIRONMENT ARE PRESENT, INCLUDING OVER-COMPACTED SOILS, ADVERSE DRAINAGE CONDITIONS, DEBRIS, OR OTHER HARMFUL CIRCUMSTANCES. PROCEEDING WITHOUT NOTIFICATION DENOTES ACCEPTANCE.
- 3. COORDINATE WITH OTHER SUBCONTRACTORS AND TRADES TO ENSURE PROTECTION OF GROWING CONDITIONS AND PLANT MATERIALS.
- 4. REFER TO SPECIFICATIONS FOR ADDITIONAL PLANTING REQUIREMENTS, METHODS, AND MATERIALS.
- 5. VERIFY PLANT QUANTITIES SHOWN ON THE PLANS BASED ON GRAPHIC REPRESENTATION. QUANTITIES SHOWN ARE FOR CONTRACTOR CONVENIENCE ONLY.
- 6. PROVIDE POSITIVE DRAINAGE FOR ALL PLANTING AREAS.
- 7. UNLESS OTHERWISE INDICATED, ALL PLANTINGS SHALL BE TRIANGULARLY SPACED.
- 8. LABELLING REFERS TO ALL ADJACENT IDENTICAL SYMBOLS WHERE PLANTS ARE MASSED. LABEL FOR MASS INDICATES TOTAL NUMBER OF PLANTS IN GROUP, EVEN IF THE GROUP IS SPREAD OVER MORE THAN ONE SHEET.

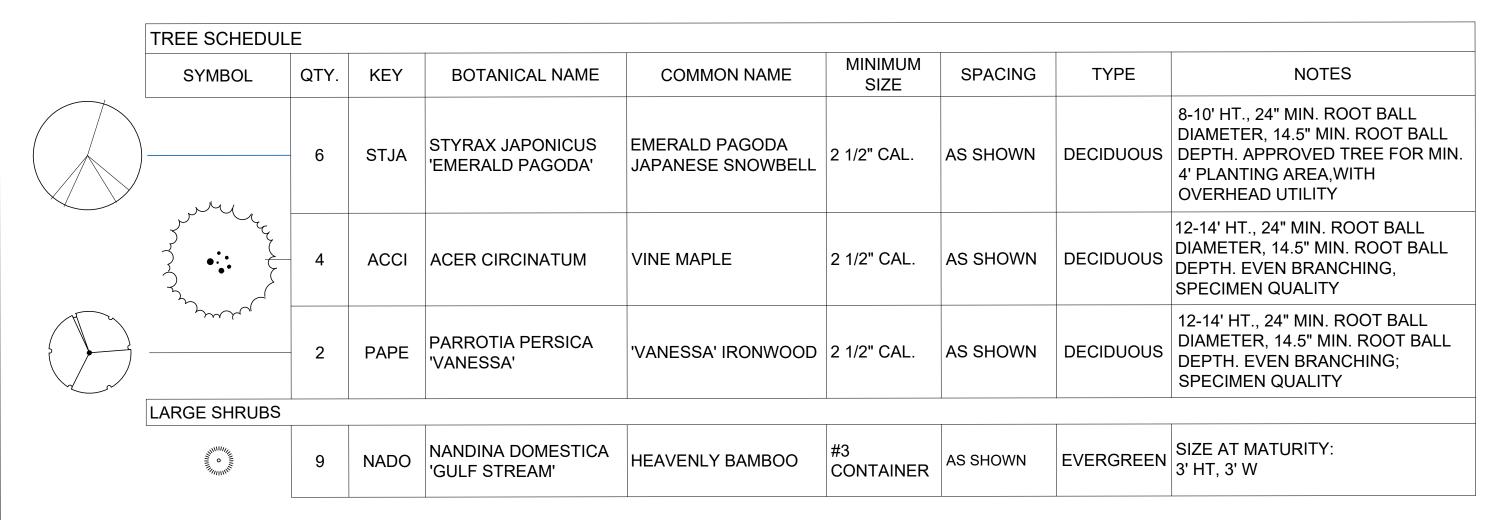

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CLIENT:

REACH CDC

4150 S MOODY AVE PORTLAND, OR 97239

PLACE PORTLAND, OR 97209

(503) 334 2080

PHASE:

PLANNING COMMISSION SET

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PLANTING SCHEDULE & NOTES

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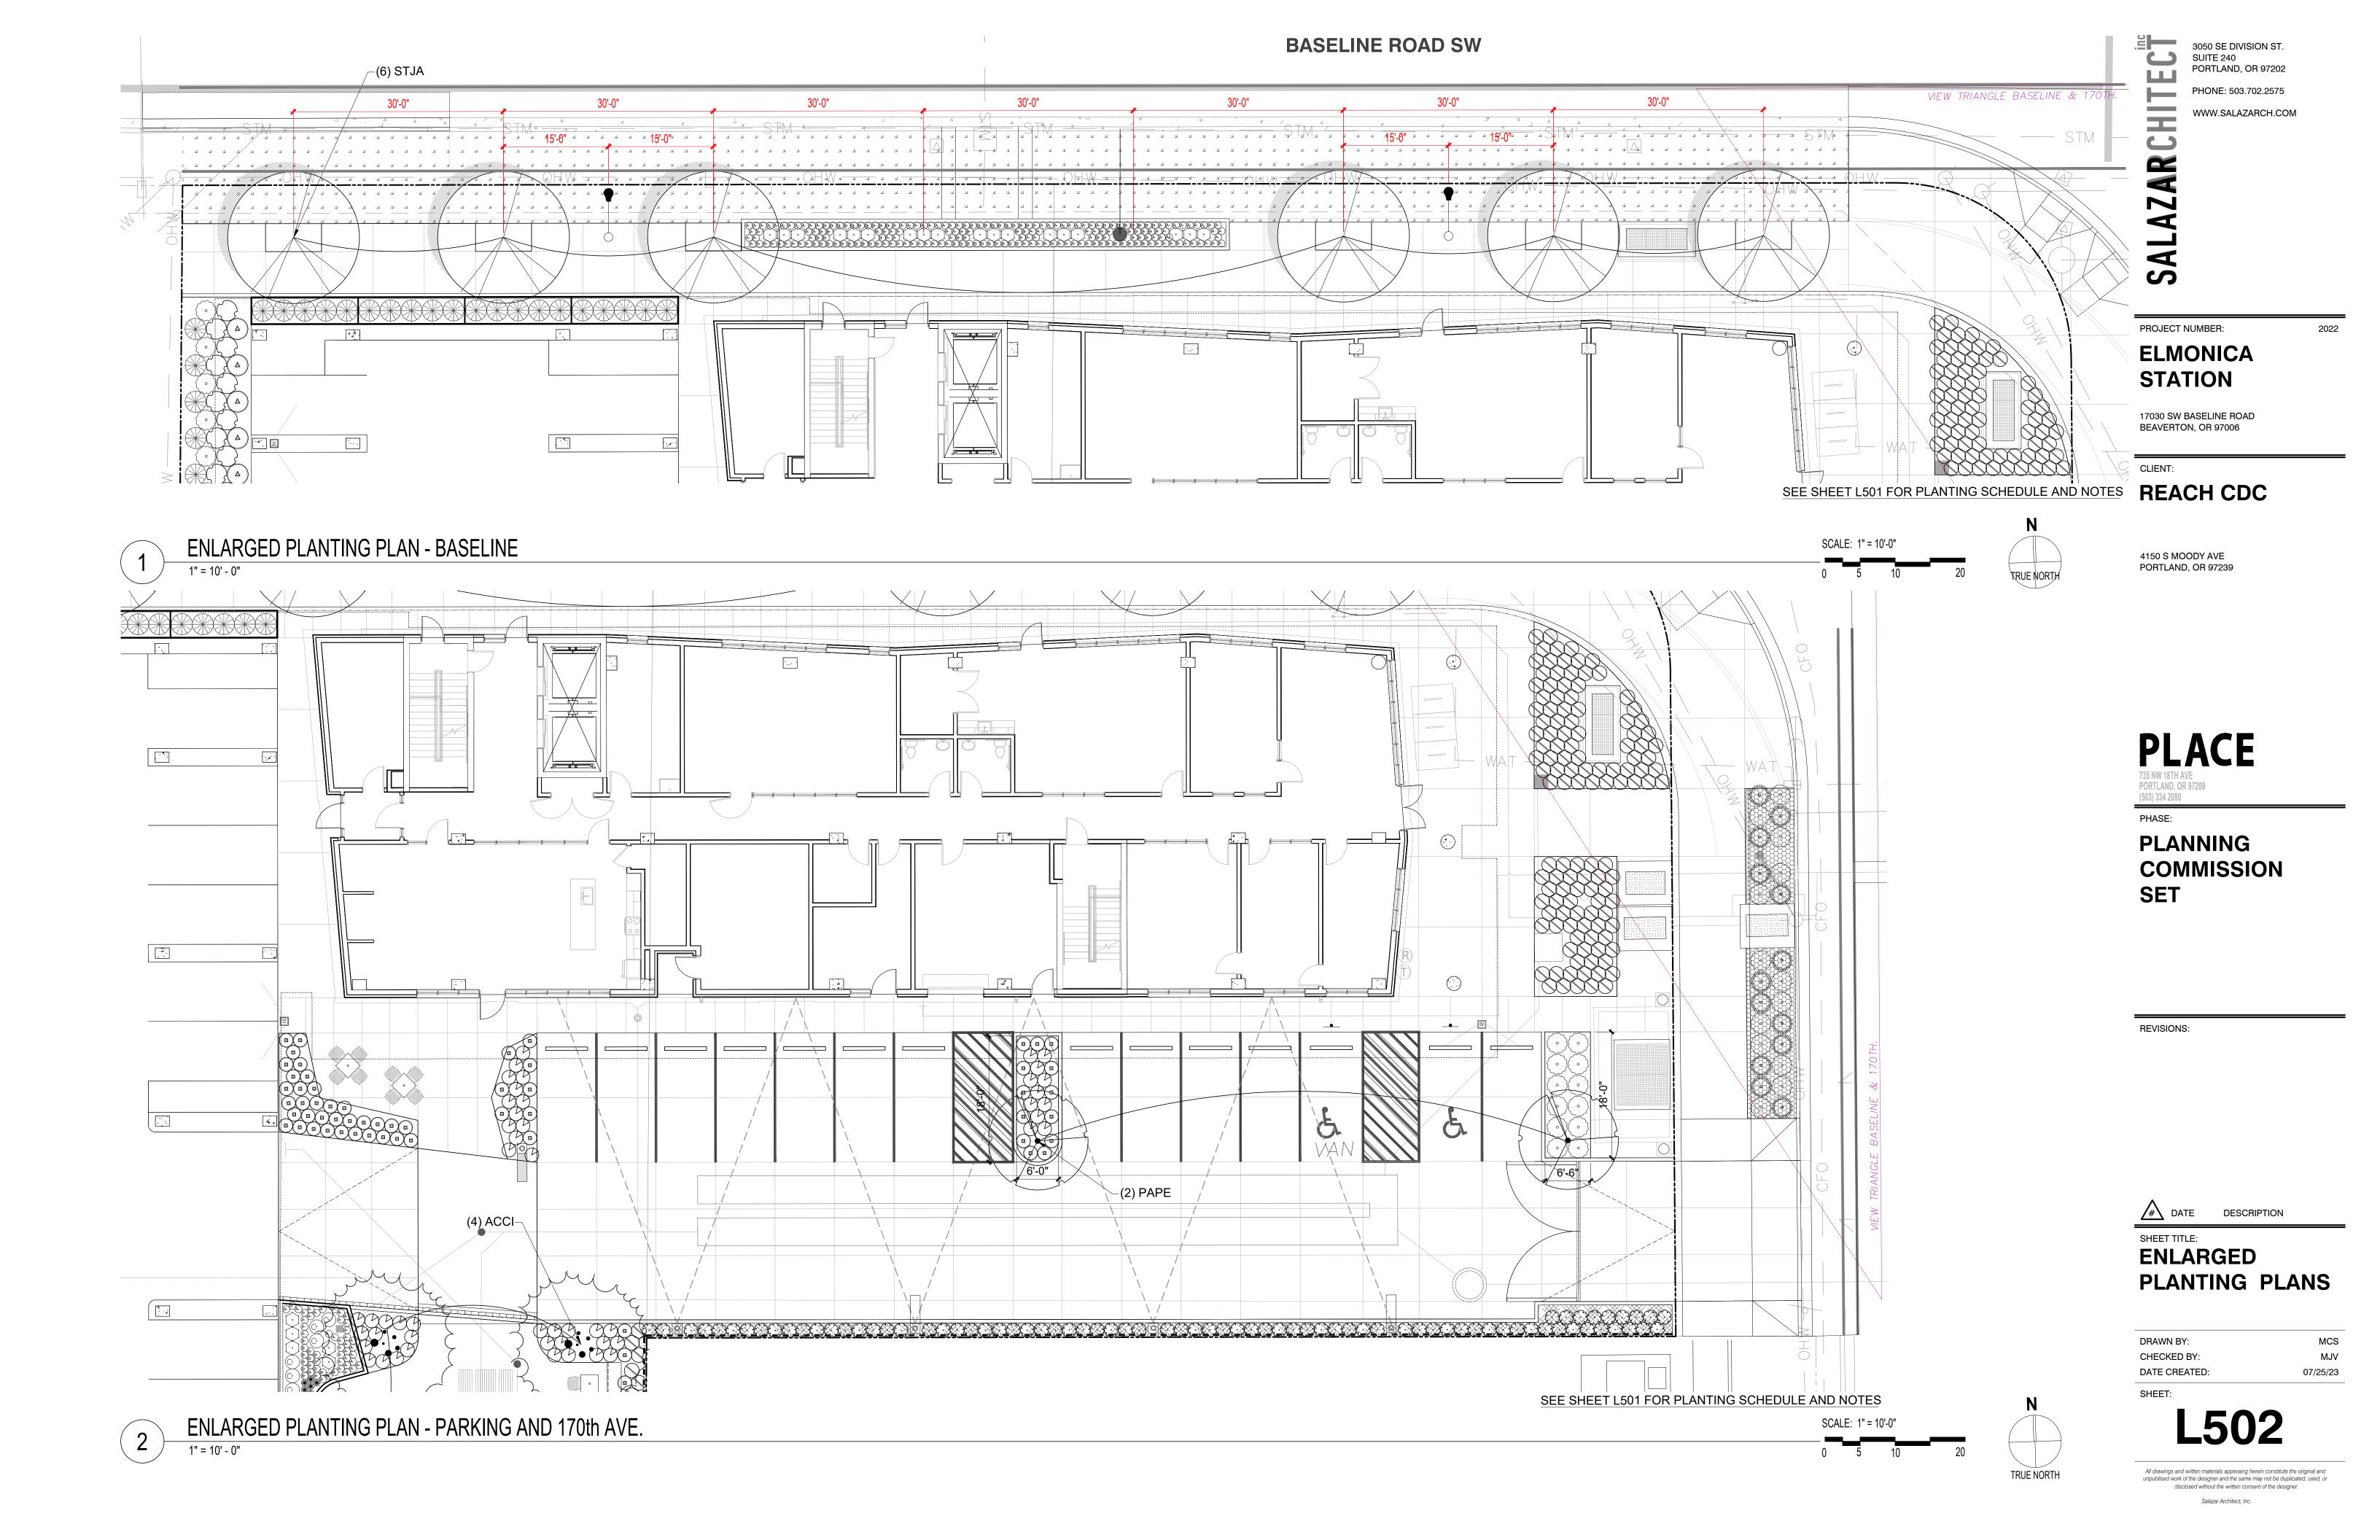
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L501

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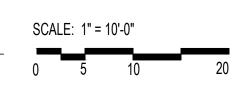
SEE SHEET L501 FOR PLANTING SCHEDULE AND NOTES

ENLARGED PLANTING PLAN - GARAGE PERIMETER NORTH

1" = 10' - 0"

SEE SHEET L501 FOR PLANTING SCHEDULE AND NOTES

ENLARGED PLANTING PLAN - GARAGE PERIMETER SOUTH & AMENITY SPACE 1" = 10' - 0"





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CLIENT:

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PLACE 735 NW 18TH AVE PORTLAND, OR 97209 (503) 334 2080

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DESCRIPTION

ENLARGED PLANTING PLANS

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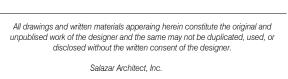
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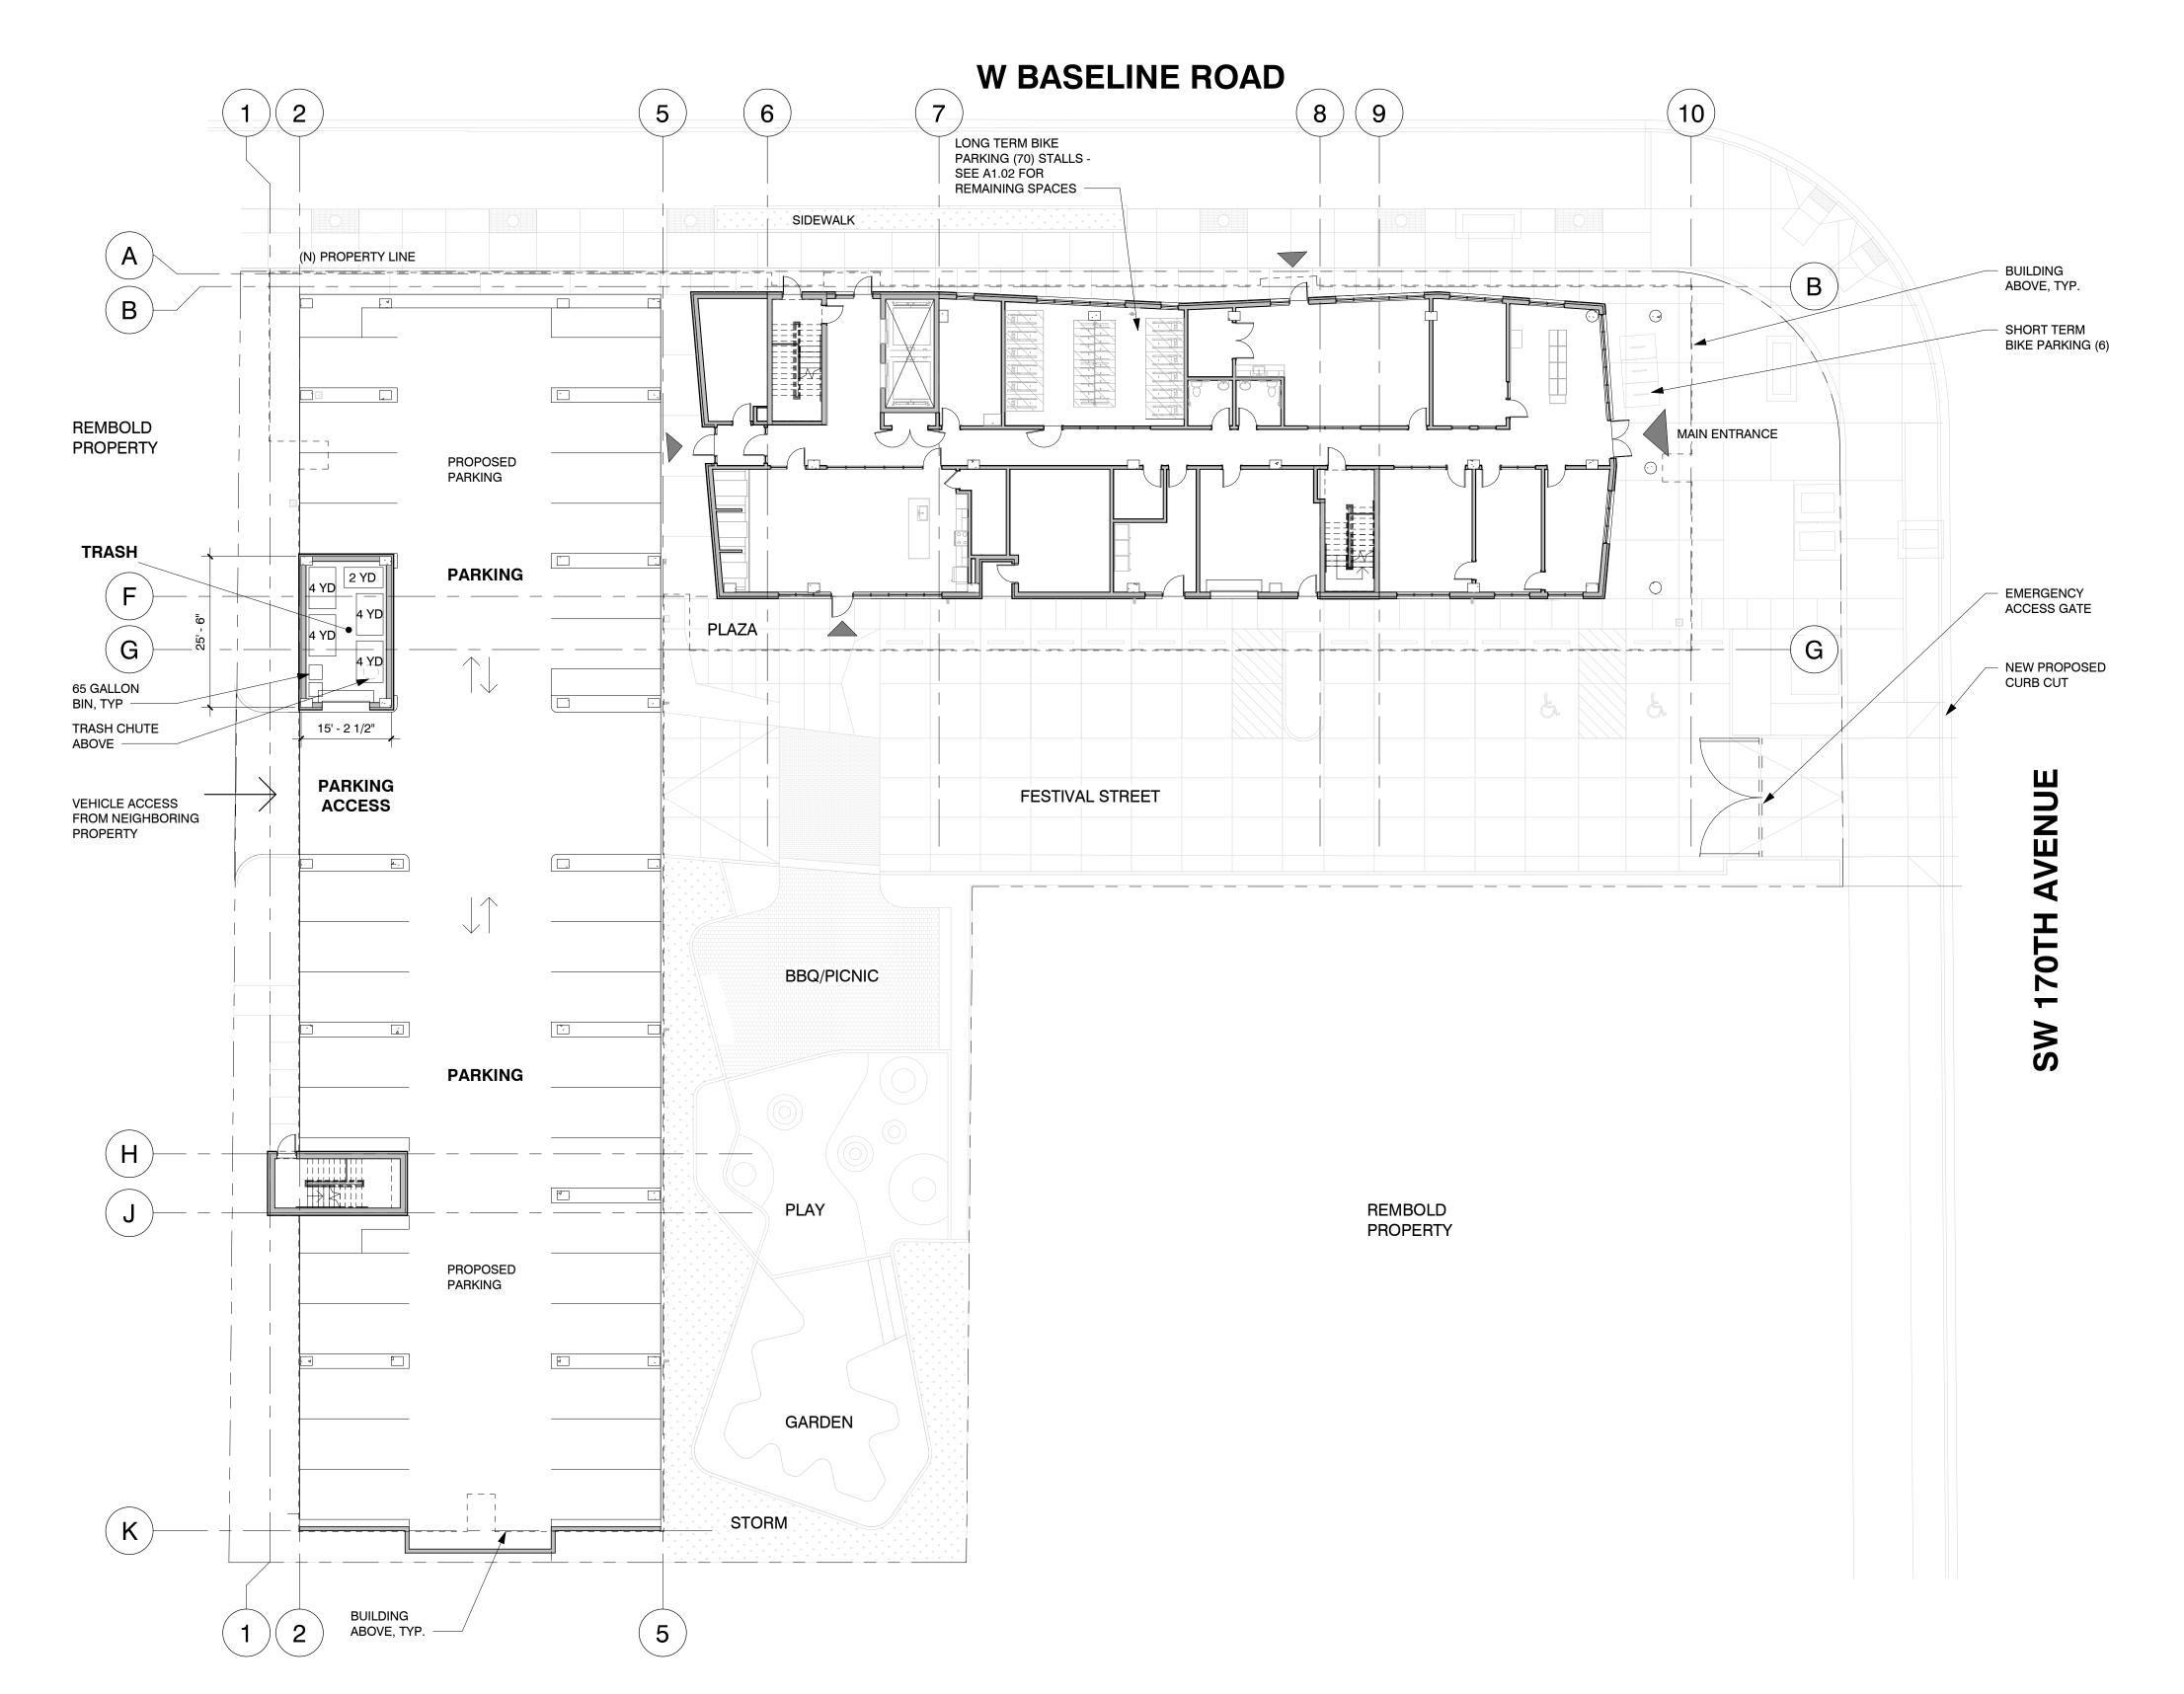
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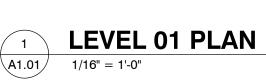
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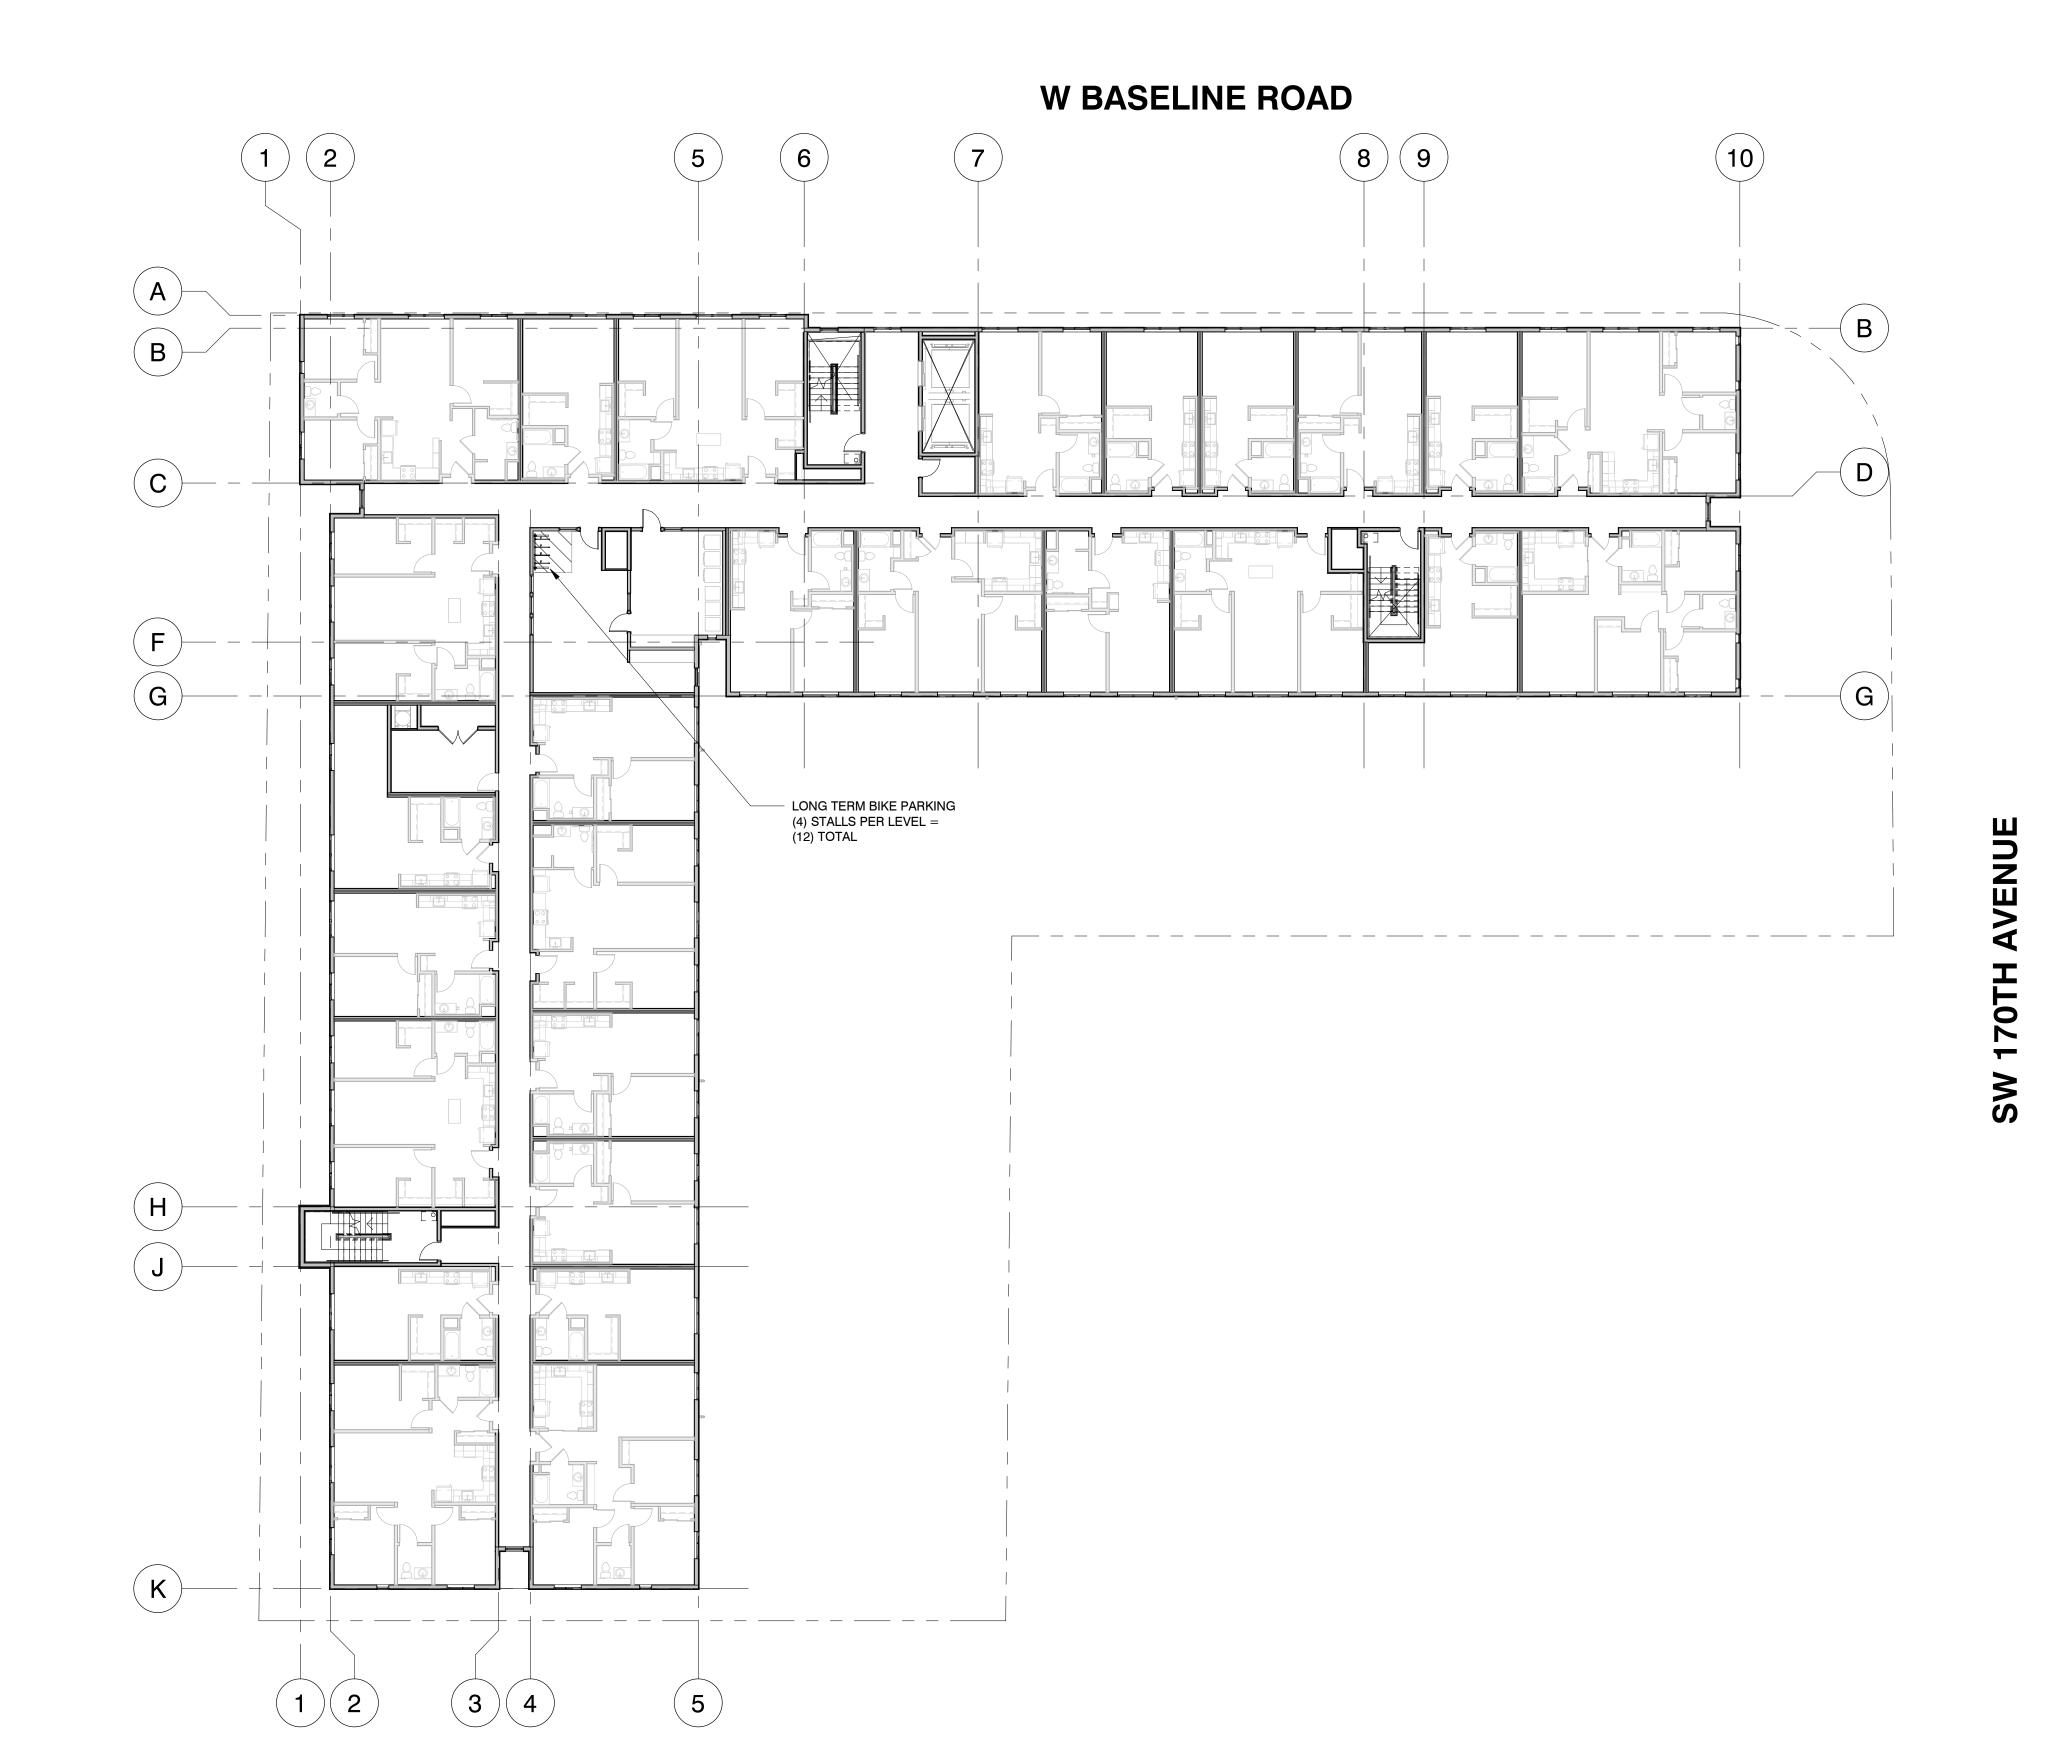
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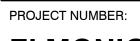
SHEET:





LEVEL 02-04 PLAN

1 **LEVEL** A1.02 1/16" = 1'-0"



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DATE DESCRIPTION

SHEET TITLE:
ROOF PLAN


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CK 08/03/23

SHEET:

\1.03





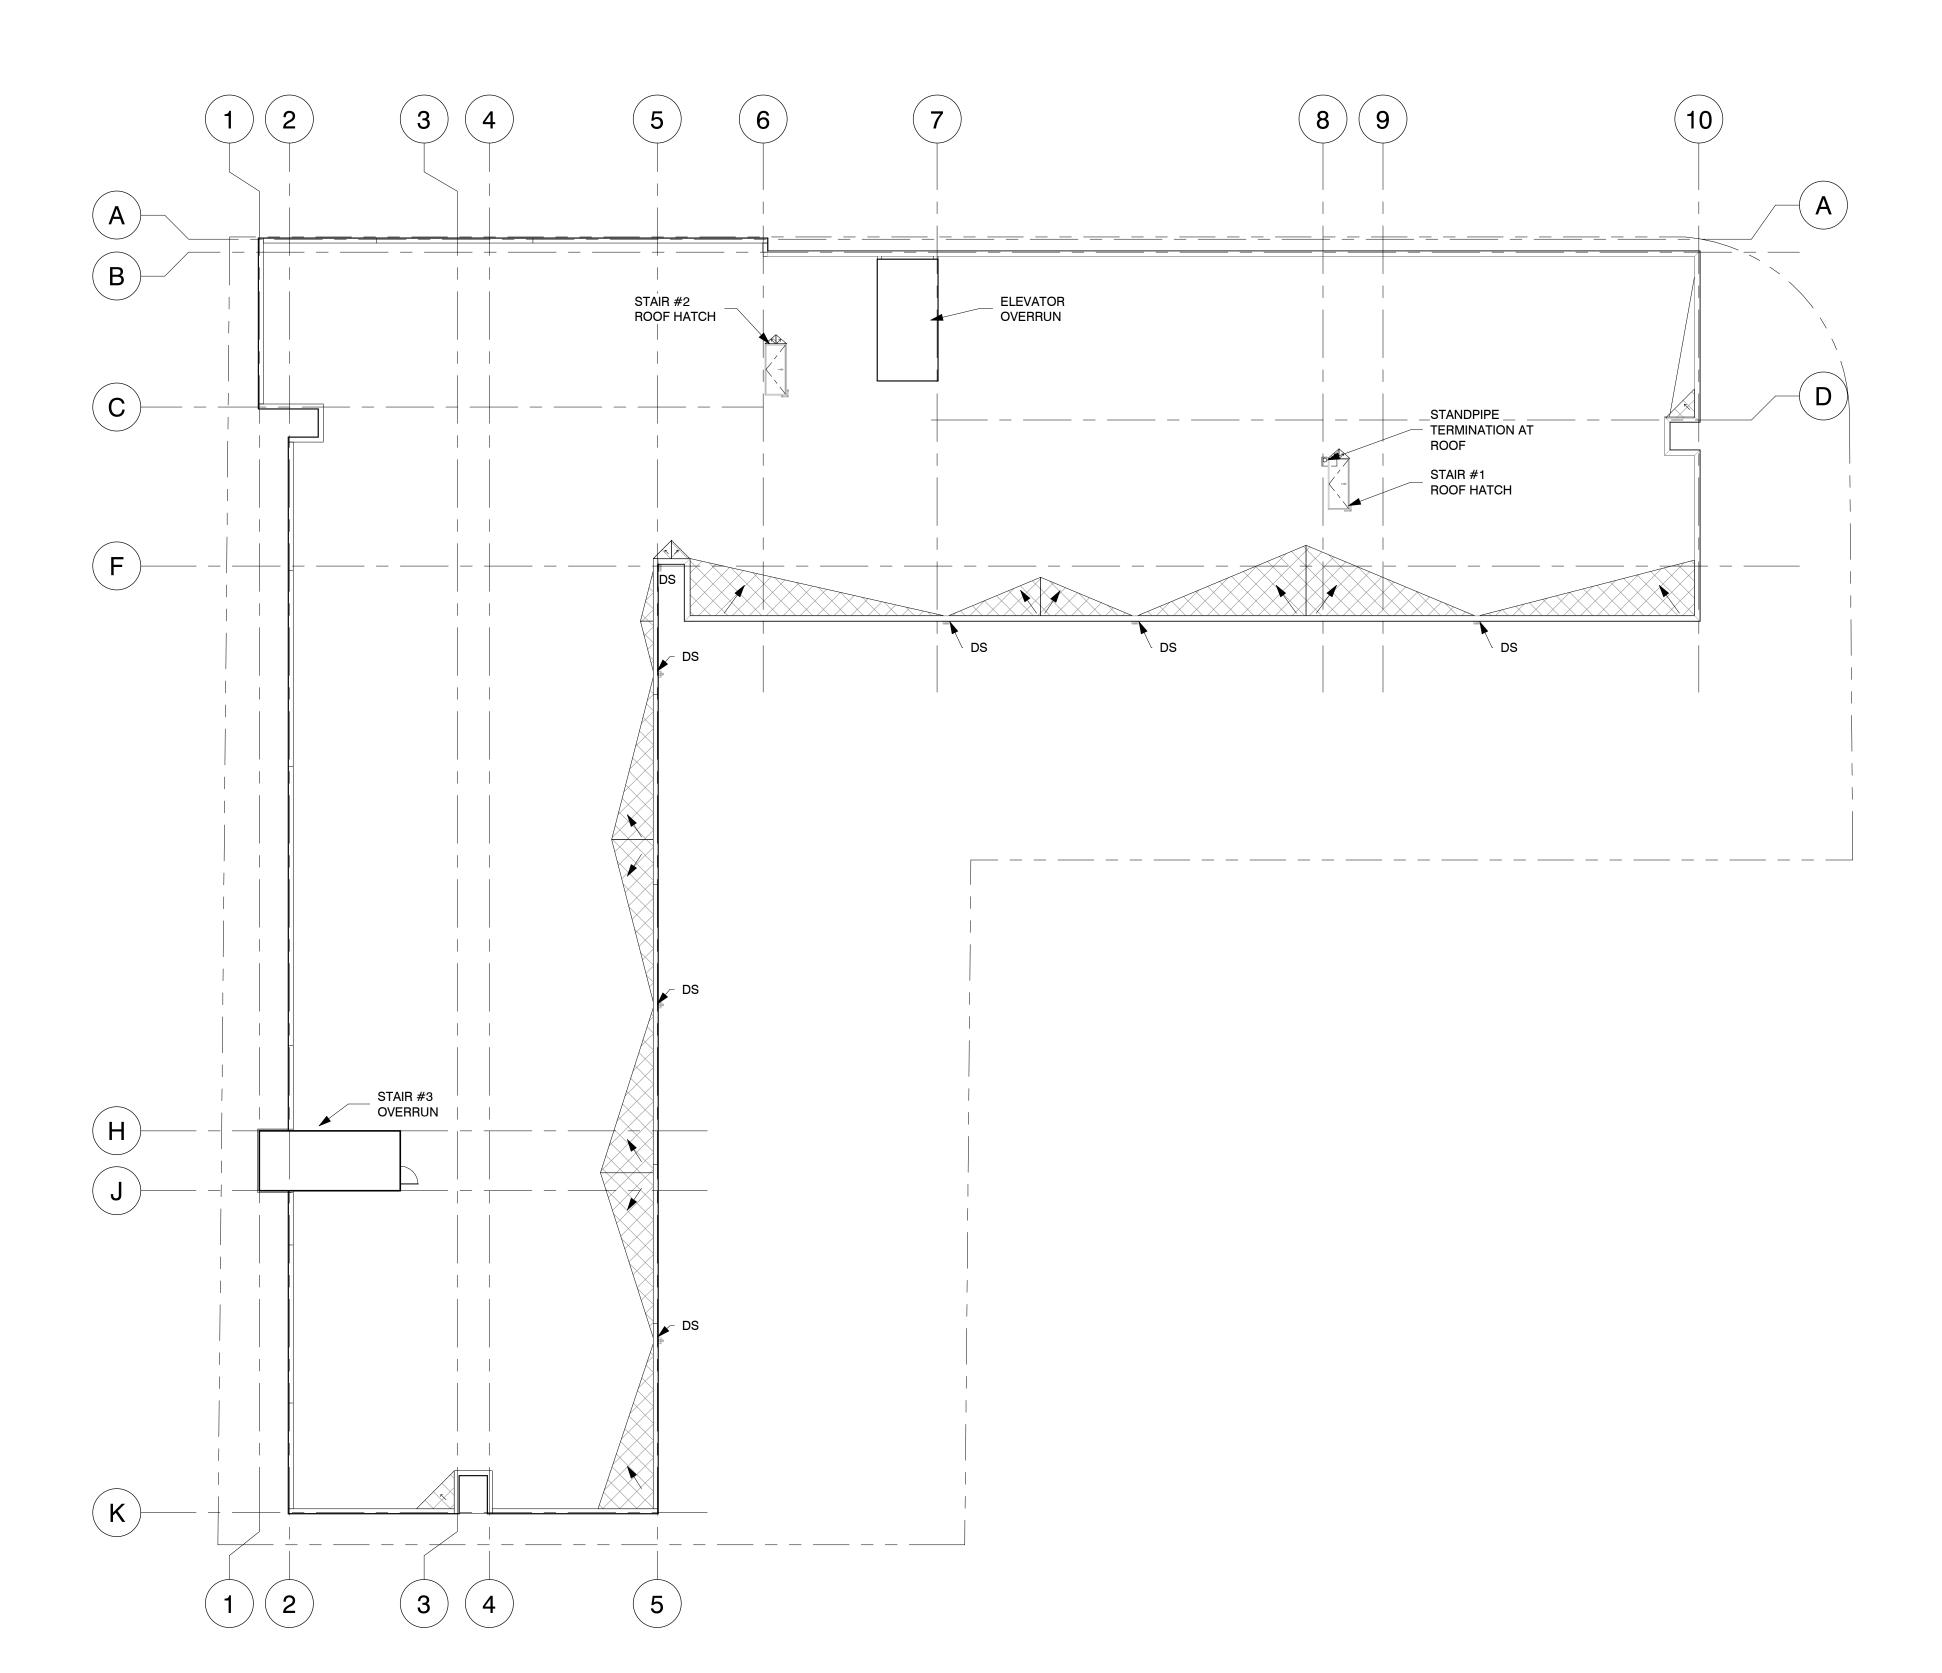

3 CUSTOM COLORS CERACLAD SMOOTH (SILK)
CERACLAD MOSAIC TILE TEXTURED (WHITE)

SHEET METAL REVEAL, SEE 3/A2.03 & 4/A2.03 SHEET METAL PARAPET CAP WITH REVEAL, SEE 5/A2.03 SHEET METAIL PARAPET CAP

ALUMINUM STOREFRONT EXPOSED CONCRETE, GRAFFITI SEAL AT EXTERIOR

LOCATIONS

METAL SCUPPER, & DOWNSPOUT WOOD SOFFIT

STEEL CANOPY, POWDER COATED

VERTICAL STEEL SCREEN, WITH INTERMEDIATE DIAGONAL MEMBERS, POWDER COATED

14. VINYL WINDOW WITH TRIM, SEE 3/A2.04

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SHEET TITLE: BUILDING **ELEVATIONS**

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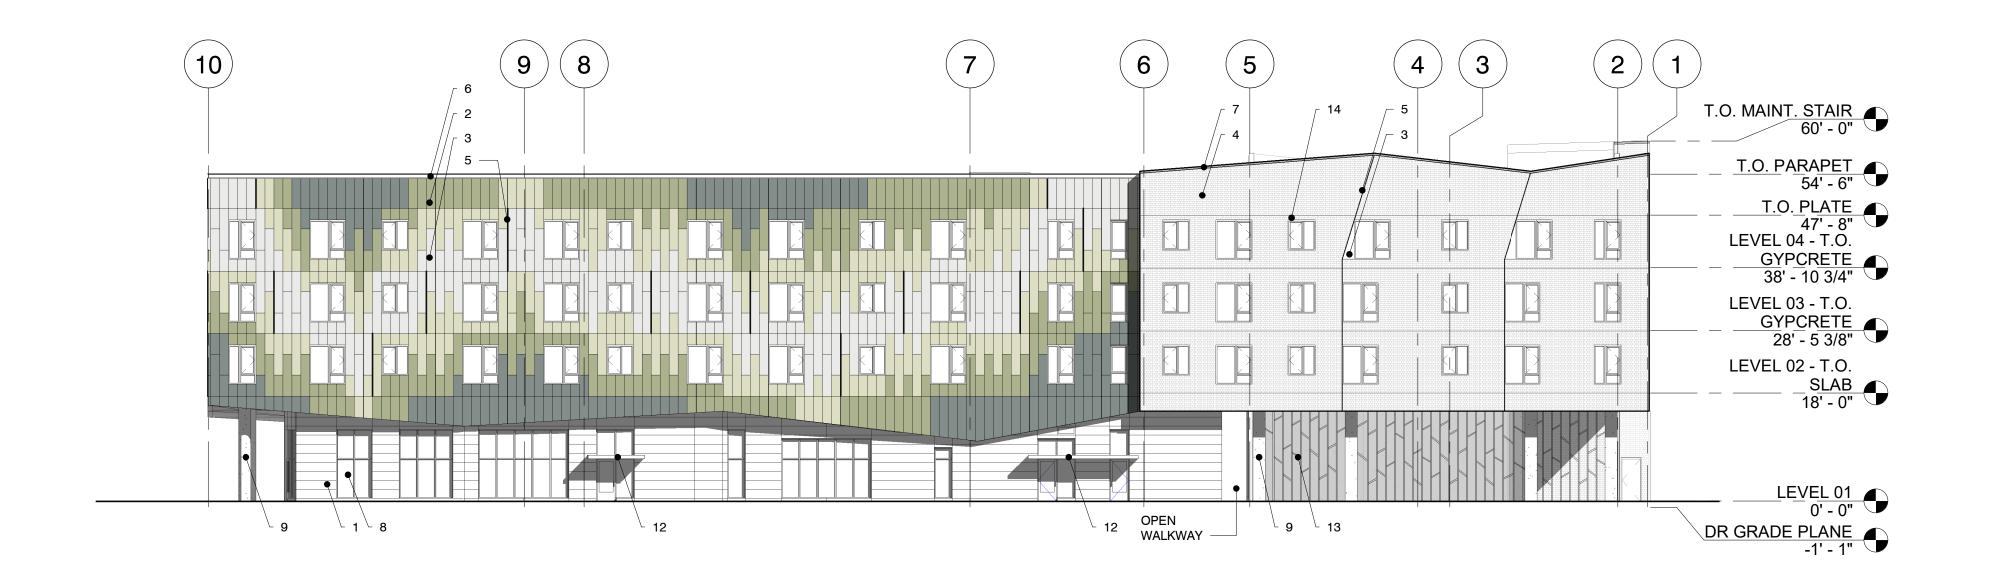
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SHEET:

A2.01


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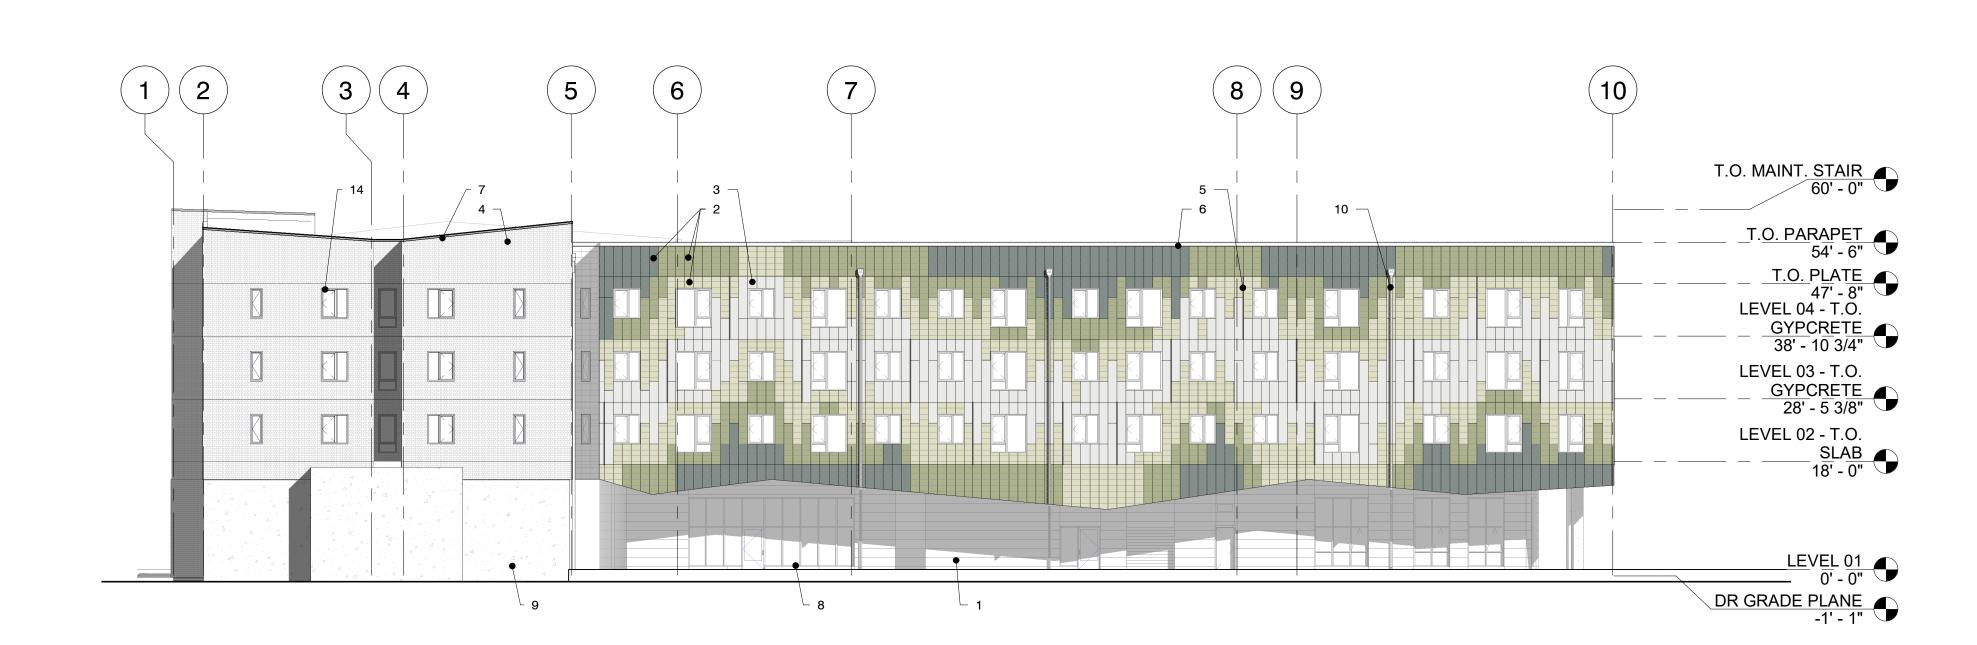





A2.01 1/16" = 1'-0"





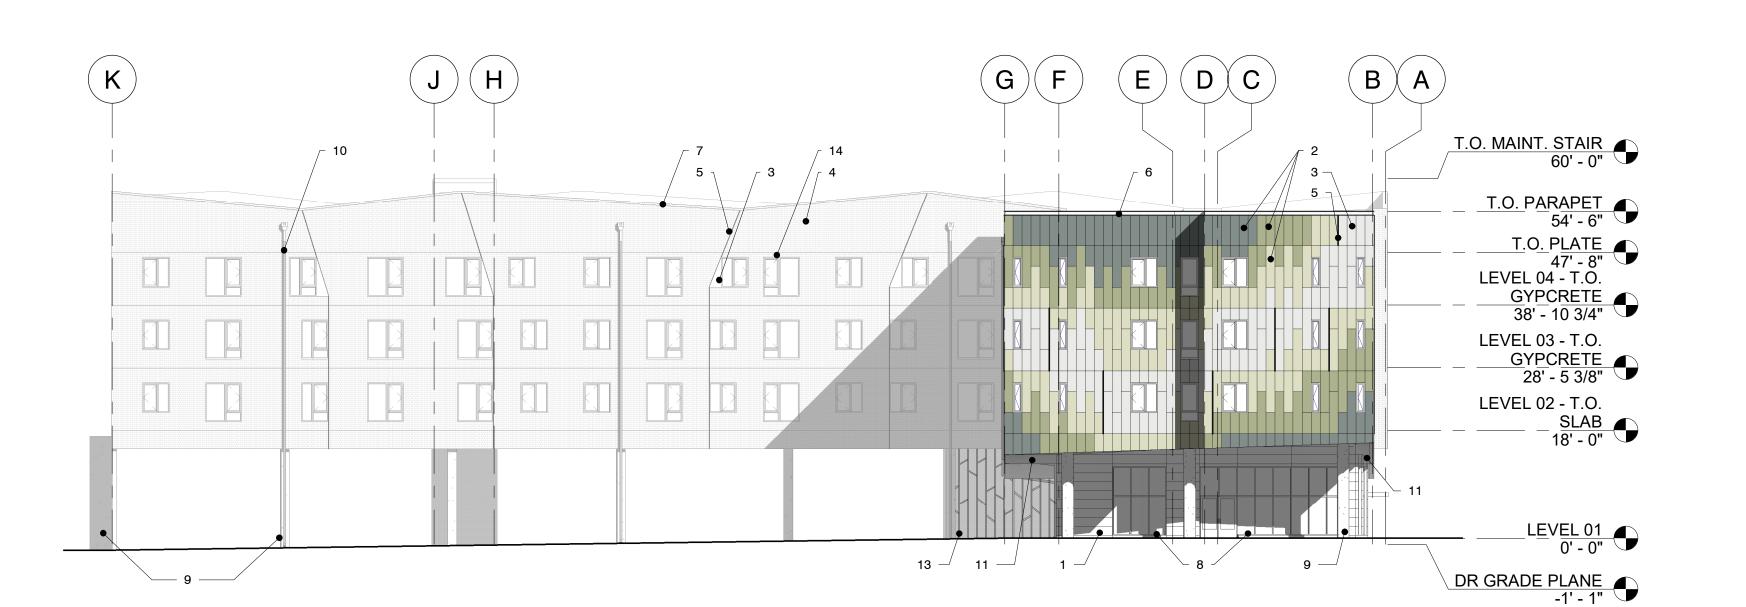



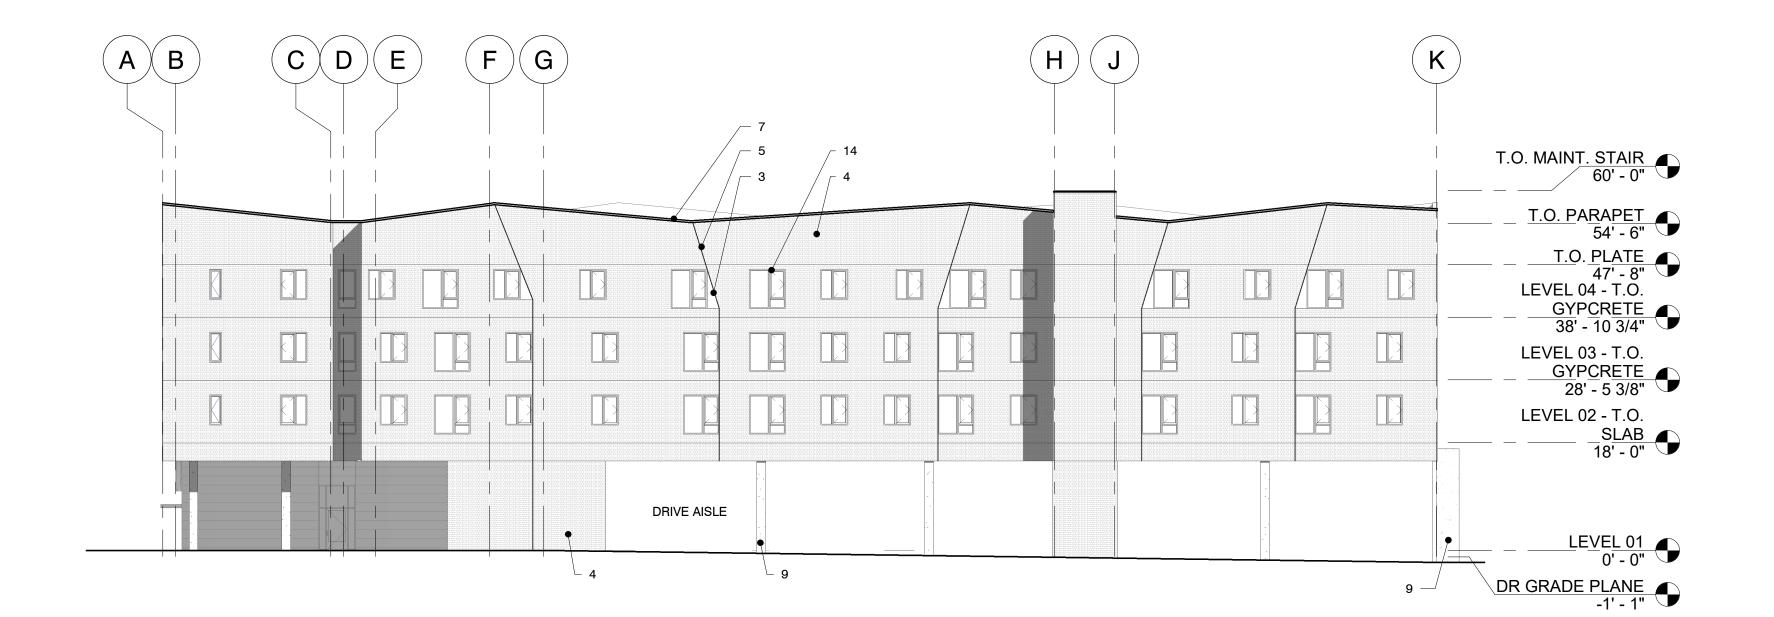



ELEVATION NOTES

CERACLAD TEXTURED (FRESH CREAM) CERACLAD ZEN GARDEN TEXTURED

3 CUSTOM COLORS

CERACLAD SMOOTH (SILK) CERACLAD MOSAIC TILE TEXTURED (WHITE) SHEET METAL REVEAL, SEE 3/A2.03 & 4/A2.03 SHEET METAL PARAPET CAP WITH REVEAL, SEE 5/A2.03

SHEET METAIL PARAPET CAP ALUMINUM STOREFRONT

EXPOSED CONCRETE, GRAFFITI SEAL AT EXTERIOR

LOCATIONS METAL SCUPPER, & DOWNSPOUT

WOOD SOFFIT

STEEL CANOPY, POWDER COATED VERTICAL STEEL SCREEN, WITH INTERMEDIATE

DIAGONAL MEMBERS, POWDER COATED 14. VINYL WINDOW WITH TRIM, SEE 3/A2.04

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SHEET TITLE: BUILDING **ELEVATIONS**

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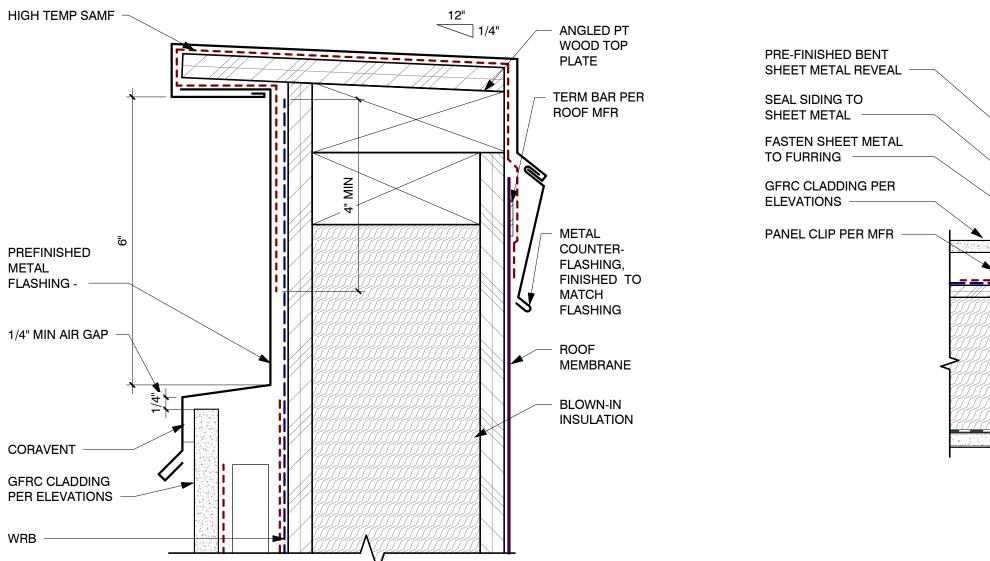
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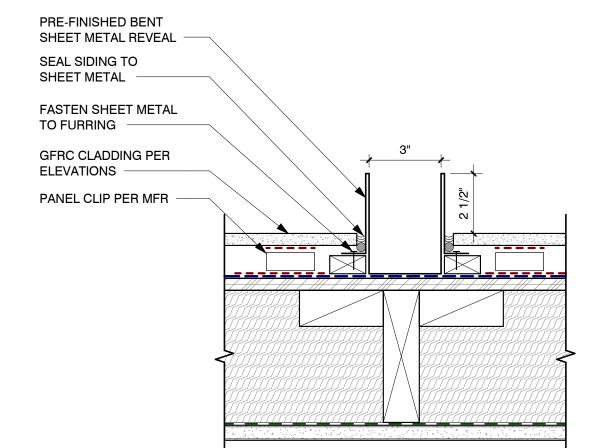
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ELEVATION NOTES

- CERACLAD TEXTURED (FRESH CREAM) CERACLAD ZEN GARDEN TEXTURED
- 3 CUSTOM COLORS
- CERACLAD SMOOTH (SILK) CERACLAD MOSAIC TILE TEXTURED (WHITE) SHEET METAL REVEAL, SEE 3/A2.03& 4/A2.03 SHEET METAL PARAPET CAP WITH REVEAL, SEE 5/A2.03
- SHEET METAIL PARAPET CAP ALUMINUM STOREFRONT
- EXPOSED CONCRETE, GRAFFITI SEAL AT EXTERIOR LOCATIONS
- METAL SCUPPER, & DOWNSPOUT
- WOOD SOFFIT
- STEEL CANOPY, POWDER COATED VERTICAL STEEL SCREEN, WITH INTERMEDIATE
- DIAGONAL MEMBERS, POWDER COATED VINYL WINDOW WITH TRIM, SEE 3/A2.04

3 CUSTOM COLORS

EXTERIOR MATERIAL LEGEND

CERACLAD PANEL, SMOOTH CERACLAD PANEL, ZEN GARDEN TEXTURED,

17030 SW BASELINE ROAD

CLIENT:

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SHEET TITLE: **BUILDING**

ELEVATIONS -ARTICULATION


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A2.03

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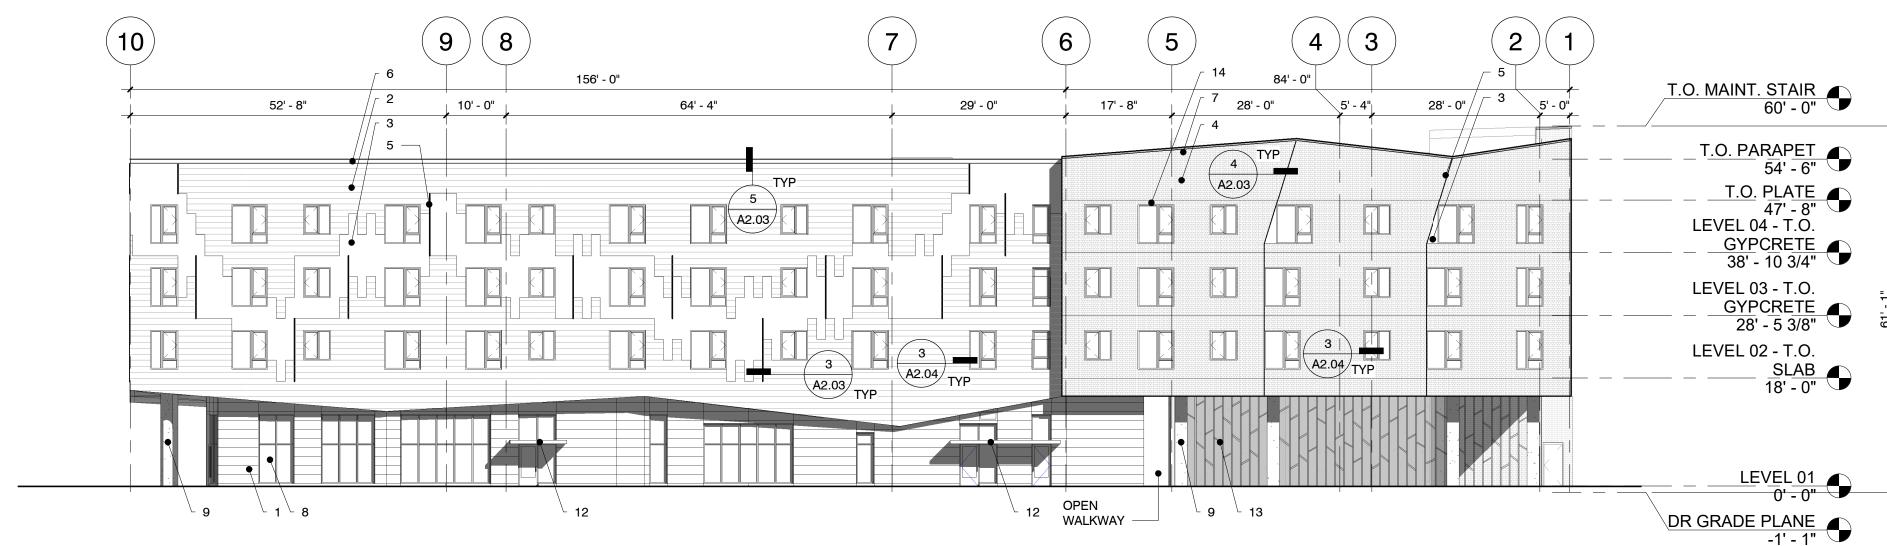
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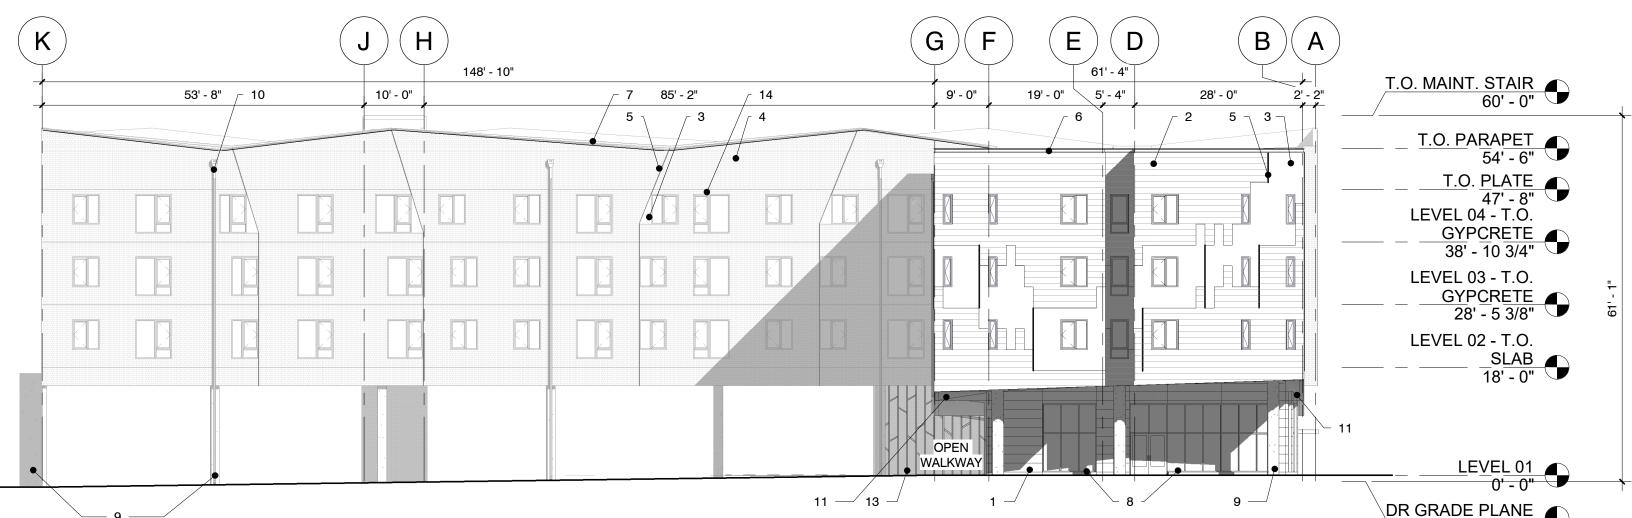
PARAPET CAP AT PANEL SIDING A2.03

REVEAL AT WINDOWS A2.03

REVEAL AT PANEL SIDING A2.03

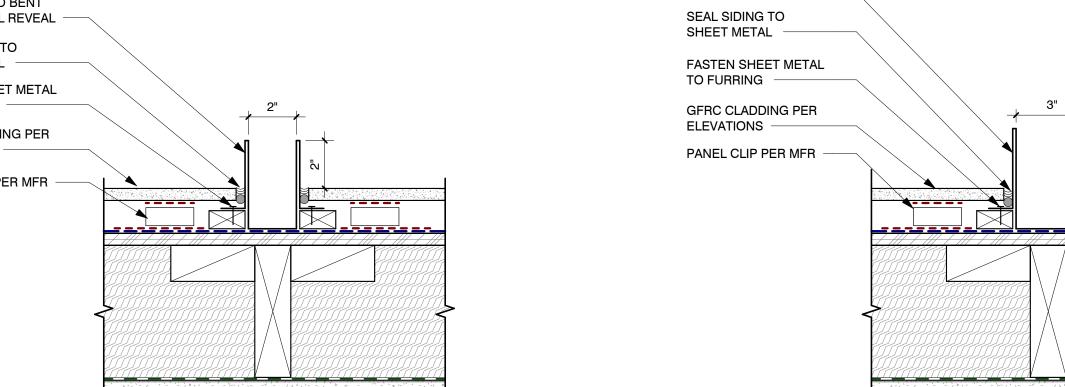

NORTH ELEVATION - TEXTURED



A2.03 1/16" = 1'-0"

A2.03 1/16" = 1'-0"

DR GRADE PLANE
-1' - 1"

ELEVATION NOTES

- CERACLAD TEXTURED (FRESH CREAM)
- CERACLAD ZEN GARDEN TEXTURED
- 3 CUSTOM COLORS
- CERACLAD SMOOTH (SILK) CERACLAD MOSAIC TILE TEXTURED (WHITE) SHEET METAL REVEAL, SEE 3/A2.03& 4/A2.03 SHEET METAL PARAPET CAP WITH REVEAL, SEE 5/A2.03
- SHEET METAIL PARAPET CAP ALUMINUM STOREFRONT
- EXPOSED CONCRETE, GRAFFITI SEAL AT EXTERIOR LOCATIONS
- METAL SCUPPER, & DOWNSPOUT
- WOOD SOFFIT STEEL CANOPY, POWDER COATED VERTICAL STEEL SCREEN, WITH INTERMEDIATE
- DIAGONAL MEMBERS, POWDER COATED 14. VINYL WINDOW WITH TRIM, SEE 3/A2.04

EXTERIOR MATERIAL LEGEND

CERACLAD PANEL, SMOOTH

CERACLAD PANEL, ZEN GARDEN TEXTURED, 3 CUSTOM COLORS

PROJECT NUMBER:

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SHEET TITLE: **BUILDING ELEVATIONS -ARTICULATION**

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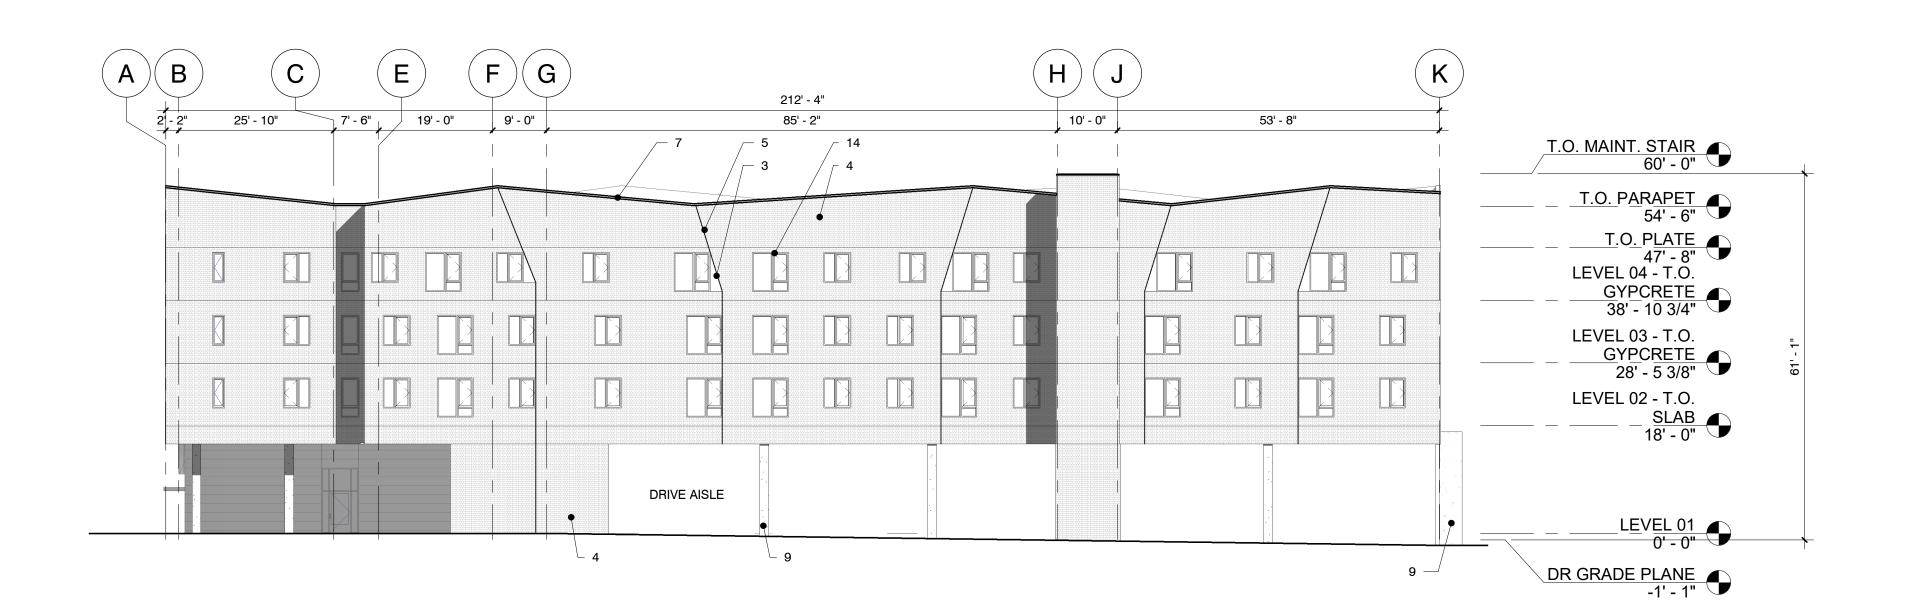
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WINDOW JAMB -TYP 3 A2.04



SOUTH ELEVATION - TEXTURED 2 A2.04

1/16" = 1'-0"



WEST ELEVATION - TEXTURED 1 WEST | 1/16" = 1'-0"

VIEW FROM CORNER OF W BASELINE ROAD AND SW 170TH AVE



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VIEW FROM SW 170TH AVE



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	DESIGN \	VALUES	ACHIEVED DESIGN VALUES			
ROADWAY SEGMENT	AVERAGE MAINTAINED ILLUMINANCE (Fc)	UNIFORMITY (AVERAGE/MINIMUM)	AVERAGE MAINTAINED ILLUMINANCE (Fc)	UNIFORMITY (AVERAGE/MINIMUM)		
SW 170th AVE	≥0.9*	≤3.0	1.1	1.9		
W BASELINE RD	≥0.9*	≤3.0	1.3	2.2		

^{*} LOW PEDESTRIAN CONFLICT AREA WAS ASSUMED.

LIGHTING ANALYSIS RESULTS-INTERSECTION

	DESIGN \	VALUES	ACHIEVED DESIGN VALUES			
INTERSECTION	AVERAGE MAINTAINED ILLUMINANCE (Fc)	UNIFORMITY (AVERAGE/MINIMUM)	AVERAGE MAINTAINED ILLUMINANCE (Fc)	UNIFORMITY (AVERAGE/MINIMUM)		
SW 170TH AVE/ W BASELINE RD	≥1.8*	≤3.0	2.1	1.4		

^{*} LOW PEDESTRIAN CONFLICT AREA WAS ASSUMED.

LIGHTING ANALYSIS RESULTS-PEDESTRIAN FACILITY

	DESIGN V	/ALUES	ACHIEVED DESIGN VALUES		
PEDESTRIAN FACILITY	PEDESTRIAN FACILITY AVERAGE MAINTAINED		AVERAGE MAINTAINED	MINIMUM	
	ILLUMINANCE (Fc)	ILLUMINANCE (Fc)	ILLUMINANCE (Fc)	ILLUMINANCE (Fc)	
SIDEWALK ALONG W BASELINE RD	≥0.4*	≥0.1	1.0	0.3	
SIDEWALK ALONG SW 170TH AVE	≥0.4*	≥0.1	0.8	0.2	

^{*} MEDIUM DENSITY RESIDENTIAL AREA WAS ASSUMED BASED ON RP-8-18 TABLE 16-3.

POLE AND LUMINAIRE SCHEDULE

	POLE NUMBER	ROADWAY	STATION	OFFSET (FT)*	POLE STYLE	BASE PLATE CONFIGURATION	MOUNTING HEIGHT (FT)	ARM LENGTH (FT)	BREAKAWAY DEVICE REQUIRED	FIXTURE STYLE	TYPE WAT	LUMINA INITIAL LUMENS	1		LIGHT LOSS FACTOR	LUMINAIRE MODEL#
Ī	1	W BASELINE RD	3+45.9	52.6	ALUMINUM DAVIT	F	30	6	NO	COBRA HEAD	LED 101	10,388	TYPE 2	B2-U0-G2	0.85	LEOTEK,GC1-60F-MV-NW-2-GY-530-PCR7-SC-WL
[2	W BASELINE RD	4+66.5	52.6	ALUMINUM DAVIT	F	30	6	NO	COBRA HEAD	LED 101	10,388	TYPE 2	B2-U0-G2	0.85	LEOTEK,GC1-60F-MV-NW-2-GY-530-PCR7-SC-WL

^{*} OFFSET IS MEASURED FROM THE ROADWAY CONSTRUCTION CENTERLINE TO THE CENTER OF THE POLE.

3050 SE DIVISION ST. PORTLAND, OR 97202 PHONE: 503.702.2575 WWW.SALAZARCH.COM

SALAZARCH

ELMONICA STATION

17030 SW BASELINE ROAD BEAVERTON, OR 97006

CLIENT:

REACH CDC



227 SW Pine St, Suite 220 Portland, Oregon 97204



SCHEMATIC DESIGN

REVISIONS:

DATE

DESCRIPTION

SHEET TITLE:

PHOTOMETRIC PLAN

DRAWN BY: CHECKED BY:

DATE CREATED:

SHEET:

IL001

06/05/23

disclosed without the written consent of the designer.















F = FIXED BASE ILLUMINATION POLE

	LAND USE LUMINAIRE SCHEDULE											
						UL/IP	DRIVER/		INPUT			
TYPE	DESCRIPTION	HOUSING	SHIELDING	MOUNTING	FINISH	RATING	POWER SUPPLY	LIGHT SOURCE	WATTS	MFG/CATALOG # NOTES		
SA	AREA LED LUMINAIRE POLE MOUNTED; TYPE IV DISTRIBUTION	NOMINAL 43.7-INCH LONG BY 6-INCH WIDE BY 4-INCH TALL ALUMINUM	TYPE IV DISTRIBUTION WITH HOUSE SIDE SHIELD	POLE MOUNTED - OVERALL HEIGHT OF 19'-0". POLE TO WITHSTAND 100 MILE PER HOUR WINDS WITH A GUST FACTOR OF 1.3. PROVIDE FLUSH CONCRETE PEDESTAL BASE.	STANDARD FINISH AS SELECTED BY ARCHITECT	WET	0-10V INTEGRAL DIMMING DRIVER	NOMINAL 5346 LUMENS, 3000K, 80 CRI	48 WATTS	SELUX ARCA SERIES, HESS, LIGMAN LIGHTING OR APPROVED		
SA1	POLE ONLY; CONNECTION FOR STRING LIGHTS	NOMINAL 6-INCH WIDE BY 4-INCH DEEP BY 19' TALL ALUMINUM		POLE MOUNTED - OVEARLL HEIGHT OF 19'-0". POLE TO WITHSTAND 100 MILE PER HOUR WINDS WITH A GUST FACTOR OF 1.3. PROVIDE FLUSH CONCRETE PEDESTAL BASE.	STANDARD FINISH AS SELECTED BY ARCHITECT	WET				SELUX ARCA SERIES, HESS, LIGMAN LIGHTING OR APPROVED		
SB	PEDESTRIAN LED LUMINAIRE POLE MOUNTED	NOMINAL 43.7-INCH LONG BY 6-INCH WIDE BY 4-INCH TALL ALUMINUM	TYPE IV DISTRIBUTION WITH HOUSE SIDE SHIELD	POLE MOUNTED - OVERALL HEIGHT 14'-0". POLE TO WITHSTAND 100 MILE PER HOUR WINDS WITH A GUST FACTOR OF 1.3. PROVIDE FLUSH CONCRETE PEDESTAL BASE.	STANDARD FINISH AS SELECTED BY ARCHITECT	WET	0-10V INTEGRAL DIMMING DRIVER	NOMINAL 3540 LUMENS, 3000K, 80 CRI	72 WATTS	SELUX ARCA SERIES, HESS, LIGMAN LIGHTING OR APPROVED		
SC	EXTERIOR WALL MOUNTED LED LUMINAIRE	NOMINAL 4-INCH SQUARE WITH PROJECTION OF 3.7-INCH	TYPE I DISTRIBUTION	WALL MOUNTED TO COLUMNS. COORDINATE WITH ARCHITECTURAL DRAWINGS.	STANDARD FINISH AS SELECTED BY ARCHITECT	WET	0-10V INTEGRAL DIMMING DRIVER	NOMINAL 570 LUMENS, 3000K, 80 CRI	6 WATTS	LIGMAN LIGHTING ULEE-30001 SERIES OR APPROVED		
SD	RECESSED 4-INCH APERATURE LED DOWNLIGHT	NOMINAL 4-INCH APERTURE BY 6-INCH DEEP STEEL HOUSING	WIDE BEAM REFLECTOR	RECESSED IN CEILING. COORDINATE CANOPY STRUCTURE.	SEMI-SPECULAR CLEAR REFLECTOR	DAMP	0-10V INTEGRAL DIMMING DRIVER	NOMINAL 1000 LUMENS, 3000K, 80 CRI	12 WATTS	PRESCOLITE LTR-4RD SERIES, GOTHAM LIGHTING, LIGHTOLIER, SPECTRUM LIGHTING OR APPROVED		
SF	LED GARAGE LUMINAIRE	NOMINAL 12-INCH DIAMETER BY 4-INCH TALL	TYPE V SQUARE WIDE	SURFACE MOUNTED. COORDINATE CEILING TYPE.	STANDARD FINISH AS SELECTED BY ARCHITECT	DAMP	0-10V INTEGRAL DIMMING DRIVER	NOMINAL 2000 LUMENS, 3000K, 80 CRI	20 WATTS	BEACON LIGHTING SRT1 SERIES OR APPROVED		
SG	LED UNDER BENCH LIGHTING	NOMINAL 0.65-INCH SQUARE IN LENGTHS AS SHOWN ON DRAWINGS		SURFACE MOUNTED. COORDINATE WITH BENCH DETAIL.	FROSTED LENS/WHITE FINISH	WET	REMOTE POWER SUPPLY	NOMINAL 162 LUMENS PER FOOT, 3000K, 80 CRI		KELVIX SIGNWAVE 3 OUTDOOR SERIES OR APPROVED PROVIDE NEMA 4 ENCLOSURE FOR REMOTE DRIVER. COORDINATE WITH LANDSCAPE DRAWINGS FOR LOCATION.		

BASELINE ROAD SW <u>-</u>\$.0 | 1.5 | 1.6 1.3 1.4 1.1 1.2 1.2 1.2 1.2 1.0 0.8 6.1 1.8 1.9 1.6'SB' 1.8 2.0 2.6 2.1 2.1 2.7 2.1 1.3 4.8 3.3 2.4 2.0 S 1 1 1 1 2 3 3 3 3 3 3 3 3 3 3 3 4 4 5 6 7 7 8 9 1 1 1 2 2 3 4 4 5 6 6 7 8 8 9 9 1 1 1 2 2 3 4 4 5 6 6 7 8 8 8 9 1 1 1 1 1 2 2 3 3 4 4 5 <t 9.4 2.4 2.9 2.4 0.6 2.2 2.8 2.5 2.5 2.5 2.5 2.5 2.6 2.7 2.8 2.3 1.4 10.7 1.5 2.6 3.6 2.9 2.9 3.7 2.8 1. 1 1 2.1 3. SF' 2.3 3.9 3.9 SF'3 3.9 1.9 1.6 2.6 4.0 2.2 4.1 4.2 2.2 3.8 1.7 3.8 1.3 3.0 3.0 3.0 1.6 2.3 2.7 3.3 2.8 2.8 3.2 2.6 1.6 1.6 2.4 3.5 3.7 3.8 3.3 1.4 2.4 3.5 3.7 3.4 3.4 9.7 3.5 2.0 1.2 3 3 2 3.7 3.8 3.1 0.9 0.1 1.4 2.5 3.0 2.6 2.6 3.2 2.7 1.6 7.3 71.5 2.3 2.8 3.2 (2.7 1.6 9.5) 0.8 2.1 3.'SF' 3.0 3.5 3.6 'SF'4 3.9 1.9 0.9 1.5 2.8 2.9 \\2.2...0...7 1.5 2.8 3.5 2 3.4 2.6 1.3 0.6 0.9 2 2 1.7 2.1 1/8

GENERAL SHEET NOTES

- MOUNTED CONCRETE PEDESTAL.
- WITH EITHER WALL MOUNTED SCONCES OR RECESSED DOWNLIGHT. REFER TO FLOOR PLAN DRAWINGS.
- 4. PARKING GARAGE PHOTOMETRICS PROVIDED AS GARAGE WALLS ARE OPEN THE EXTERIOR.
- 5. PHOTOMETRIC CALCULATIONS ARE AT GRADE LEVEL ON
- 8. LLF OF 0.90.



- 2. PEDESTRIAN POLE MOUNTED LUMINAIRE, TYPE SB SERIES, HAVE A MOUNTING HEIGHT OF 14'-8" ABOVE GRADE. FLUSH

- AREA POLE MOUNTED LUMINAIRE, TYPE SA SERIES, HAVE A MOUNTING HEIGHT OF 19-7" ABOVE GRADE. FLUSH
- MOUNTED CONCRETE PEDESTAL.

- 6. CALCULATIONS ARE THE EXPECTED AVERAGE MAINTAINED ILLUMINATION AT GRADE DURING NORMAL LIFE OF LIGHT
- 7. ISO-ILLUMINANCE LINES INDICATE 1 FOOTCANDLE AND 0.5 FOOTCANDLE FOR OVERALL SITE.



- PAVEMENT OR CONCRETE SURFACES.

REACH CDC

CLIENT:

SALAZARCH

PROJECT NUMBER:

STATION

ELMONICA

17030 SW BASELINE ROAD BEAVERTON, OR 97006

4150 S MOODY AVE PORTLAND, OR 97239

3050 SE DIVISION ST.

PORTLAND, OR 97202

PHONE: 503.702.2575

WWW.SALAZARCH.COM

SUITE 240



100% DESIGN **DEVELOPMENT**

REVISIONS:

DATE DESCRIPTION

SHEET TITLE: SITE PLAN -**PHOTOMETRICS**

DRAWN BY: CHECKED BY: DATE CREATED:


06.16.23

SHEET:

disclosed without the written consent of the designer. Salazar Architect, Inc.



CONTACT Deborah Raines 100 SW Main Street, Suite 1600 Portland, OR 97204 TEL 503.382.2266 www.interfaceengineering.com

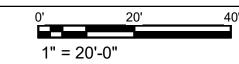

0.3 0.0 0.0 1.8 1.4 1.3 1.4